PRIMARY HEALTH CARE UNIT (PHCU) (Black Cotton Soil)

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 Depth of strip foundation 750mm.
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Program



Enhancing Community Resilience and Local Governance Project

GOVERNMENT OF SOUTH SUDAN

Implemented By:




PROPOSED PRIMARY HEALTH CARE UNIT

Drawing Tittle

COVER PAGE

Designed By: H.A	Drawn by: H.A
Checked: F.E & G.O	Approved:
Sheet #: 1/16	Scale: AS SPECIFIED
Date: 28 May 2024	Rev: 2

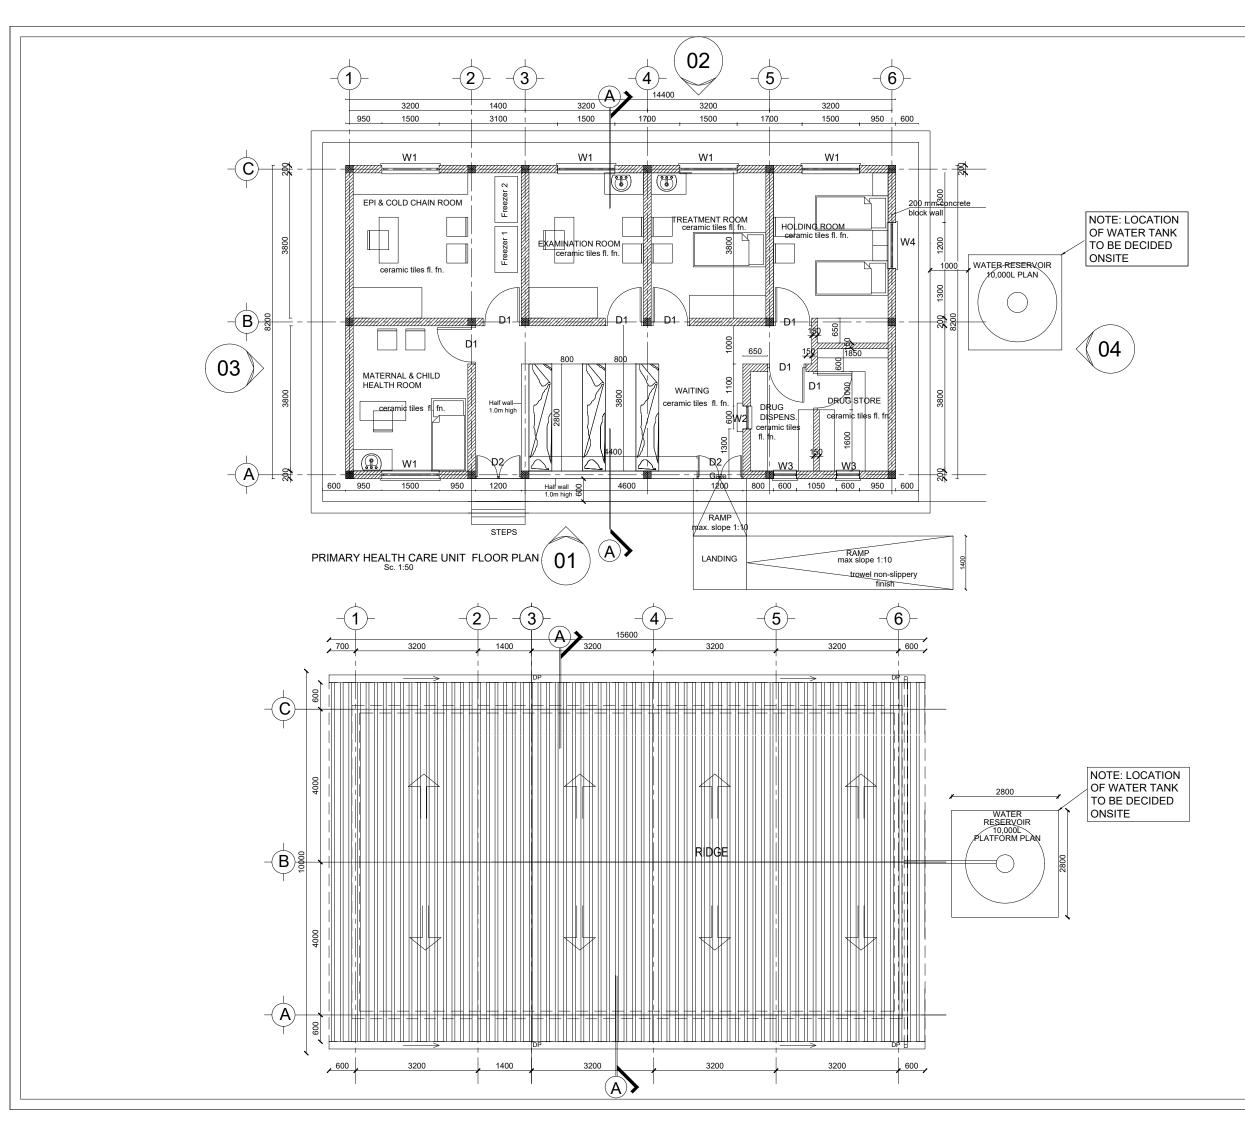

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Enhancing Community Resilience and Local Governance Project

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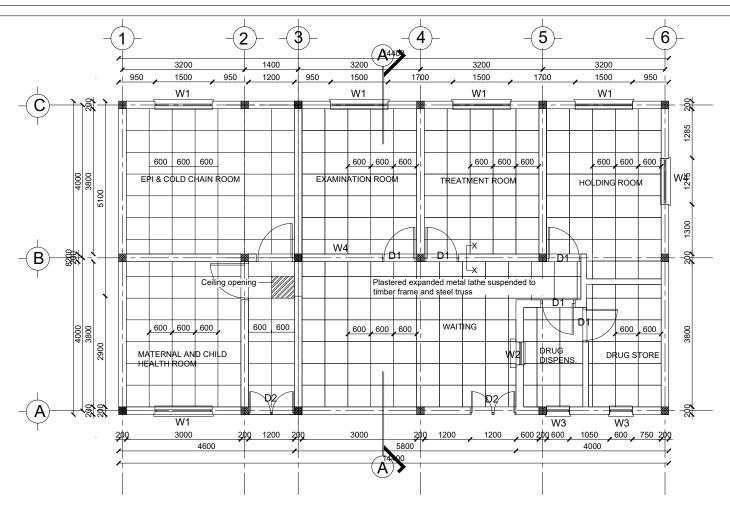


PROPOSED PRIMARY HEALTH CARE UNIT


Drawing Tittle

FLOOR PLAN AND ROOF PLAN

Designed By:	: Н.А	Drawn by: H.A
Checked:	F.E & G.O	Approved:
Sheet #:	2/16	Scale: AS SPECIFIED
Date:	28 May 2024	Rev: 0



PRIMARY HEALTH CARE UNIT CEILING PLAN

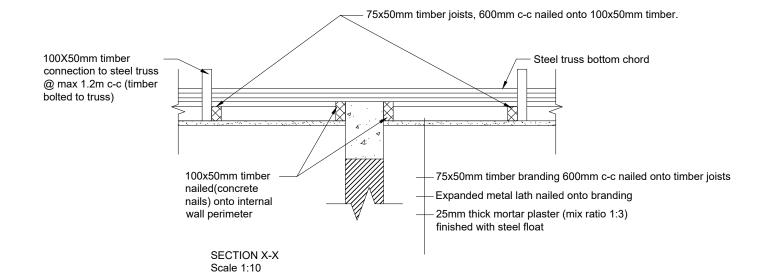

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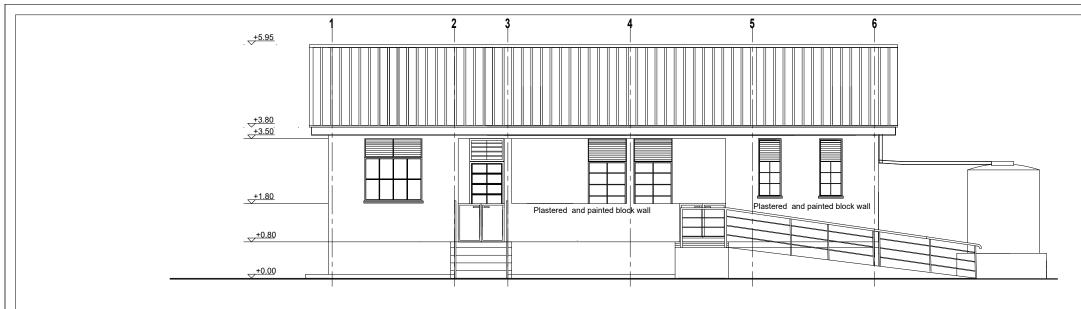


PROPOSED PRIMARY HEALTH CARE UNIT

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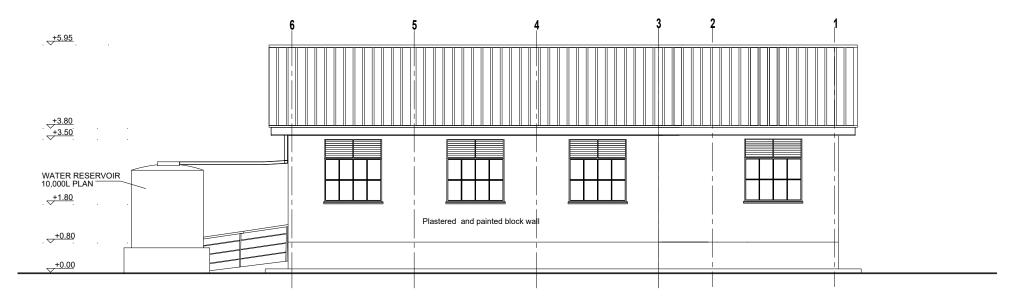
CEILING PLAN

Designed By:	H.A	Drawn by: H.A
Checked:	F.E & G.O	Approved:
Sheet #:	3/16	Scale: AS SPECIFIED
Date:	28 May 2024	Rev: 2




01 FRONT ELEVATION


Sc. 1:50



02 REAR ELEVATION

Sc. 1:50

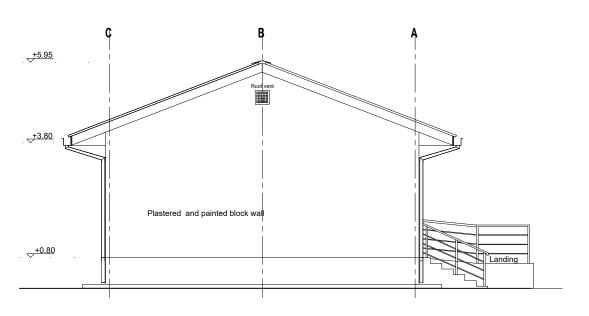

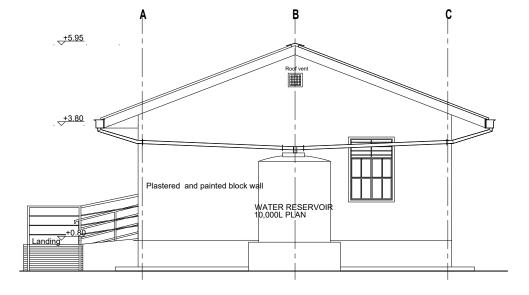

03 LEFT SIDE ELEVATION

Sc. 1:50

04 RIGHT SIDE ELEVATION

Sc. 1:50

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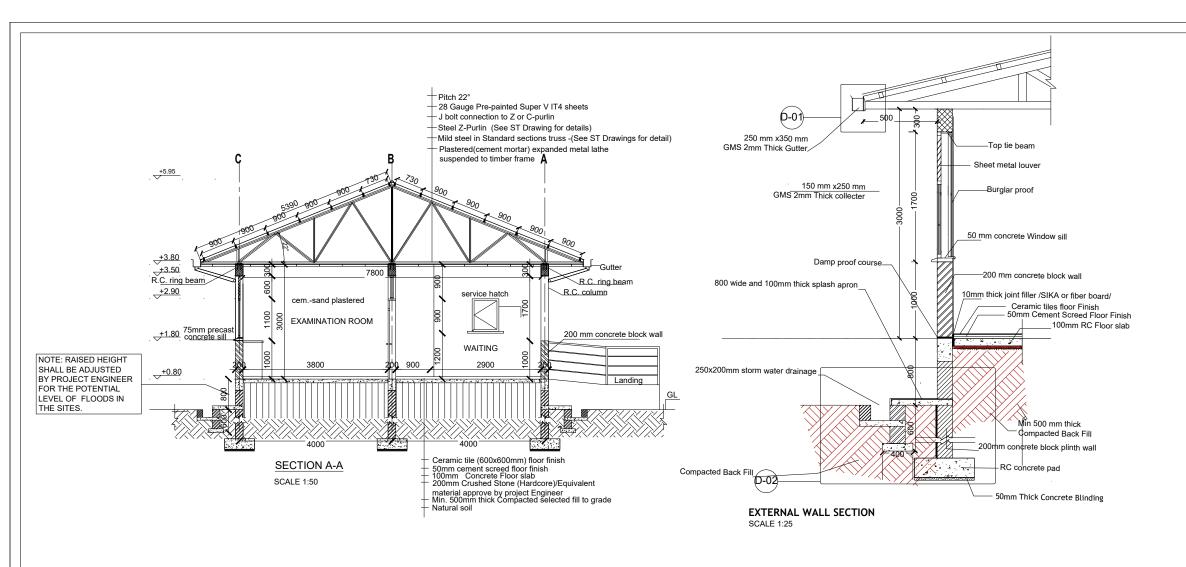



PROPOSED PRIMARY HEALTH CARE UNIT


Drawing Tittle


FLEVATIONS

Designed E	By: H.A	Drawn by: H.A
Checked:	F.E & G.O	Approved:
Sheet #:	4/16	Scale: AS SPECIFIED
Date:	28 May 2024	Rev: 2




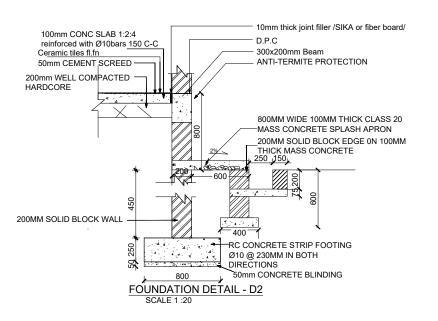

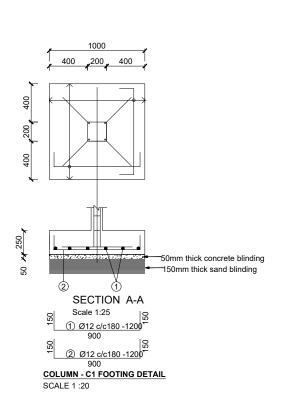

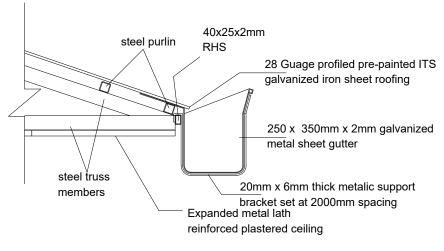

Detail 01: Overhung Gutter Detail sc. 1:8

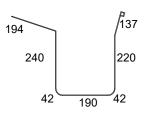

Gutter Development total Length = 1065mm sc. 1:8

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PROPOSED PRIMARY HEALTH CARE UNIT

Drawing Tittle

SECTION AND DETAILS

2ECTION AIN	D DETAILS	
Designed By:	H.A	Drawn by: H.A
Checked:	F.E & G.O	Approved:
Sheet #:	5/16	Scale: AS SPECIFIED
Date:	28 May 2024	Rev: 2
	Designed By: Checked: Sheet #:	Sheet #: 5/16

STRUCTURAL NOTES:

- Building shall be founded on load bearing stone/concrete block masonry wall having a depth of 750mm and pad foundation depth of 1200mm from the natural ground level with bottom of excavation compacted prior to laying the foundation wall.
- Stone masonry foundation shall be on reinforced concrete strip footing placed on the natural II) black cotton soil and achieve a minimum bearing capacity of 100 KN/m2.
- III) Foundation trench excavation to be approved by the Engineer prior to the construction of footing and the stone/block masonry foundation.
- IV) **Material Specification**
- A) Grade of Structural Concrete

C-25 (Cube characteristics strength of 25 MPa, mix ratio 1:1.5:3) for columns and beams;

C-20 (Cube characteristics strength of 20 MPa, mix ratio 1:2:4) for floor slab.

Concrete reinforcement bar

Grade 460 (Characteristics yield strength of fyk = 460 MPa)

Steel hollow section for roofing system, verandah column and plates

Grade C: Tensile Strength = 375 Mpa

Yield Strength = 275 Mpa

D) Grade of Bolts

Grade 4.6: Yield Strength = 240 Mpa

Tensile Strength = 400 Mpa

- **Durability Requirements**
- Concrete Cover to Reinforcement
 - Floor slabs: 25mm.
 - Beams: 25mm
 - Columns: 25mm
 - All foundation (below the ground level): 50mm
- Protection of steel work
 - Surface preparation by blast cleaning, pickling process or where approved by wire brushing
 - Application of one coat of an approved pre-fabrication fabrication primer e.g. Zinc
 - Two coats of an approved paint system to be proposed by Architect, one applied at shop and the other on site after erection.

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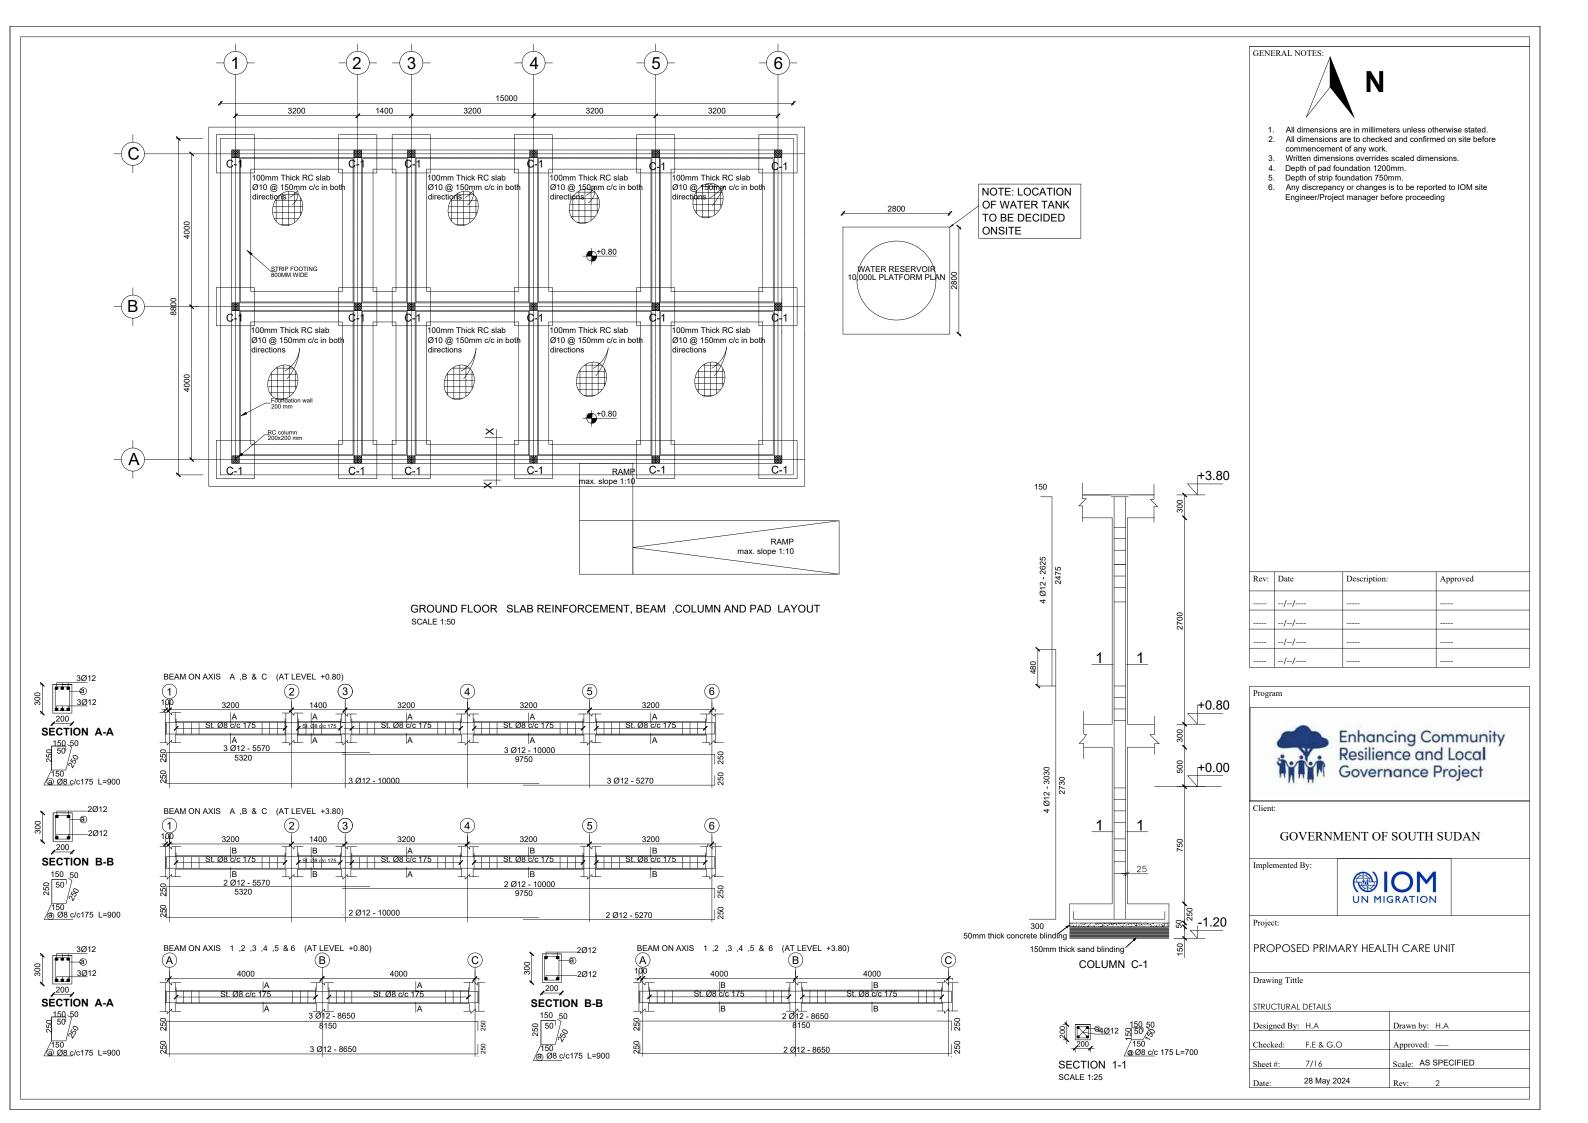



PROPOSED PRIMARY HEALTH CARE UNIT


Drawing Tittle


STRUCTURAL NOTES


Designed By	: Н.А	Drawn by: H.A
Checked:	F.E & G.O	Approved:
Sheet #:	6/16	Scale: AS SPECIFIED
Date:	28 May 2024	Rev: 2



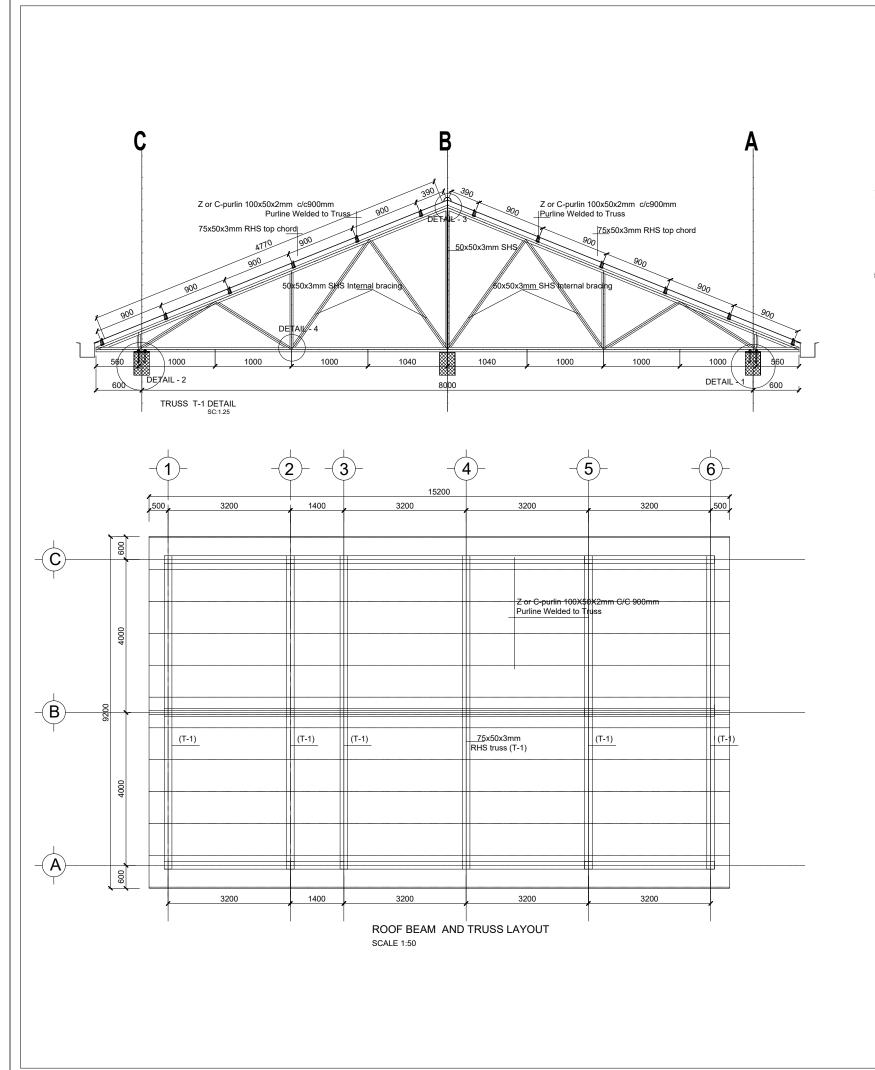

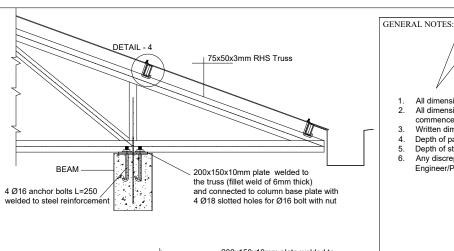


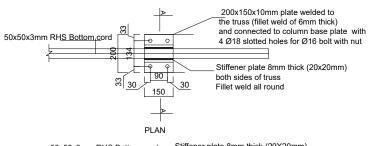

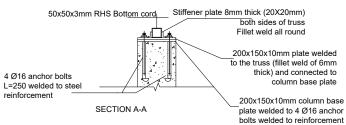

DETAIL - 2 SCALE 1:10

DETAIL - 4 SCALE 1:5

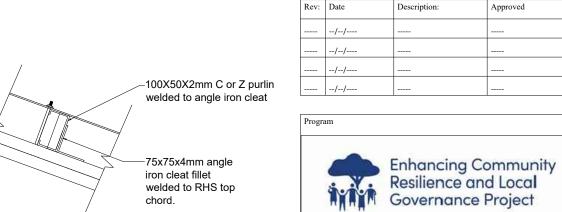

chord.

welded to RHS top

GOVERNMENT OF SOUTH SUDAN

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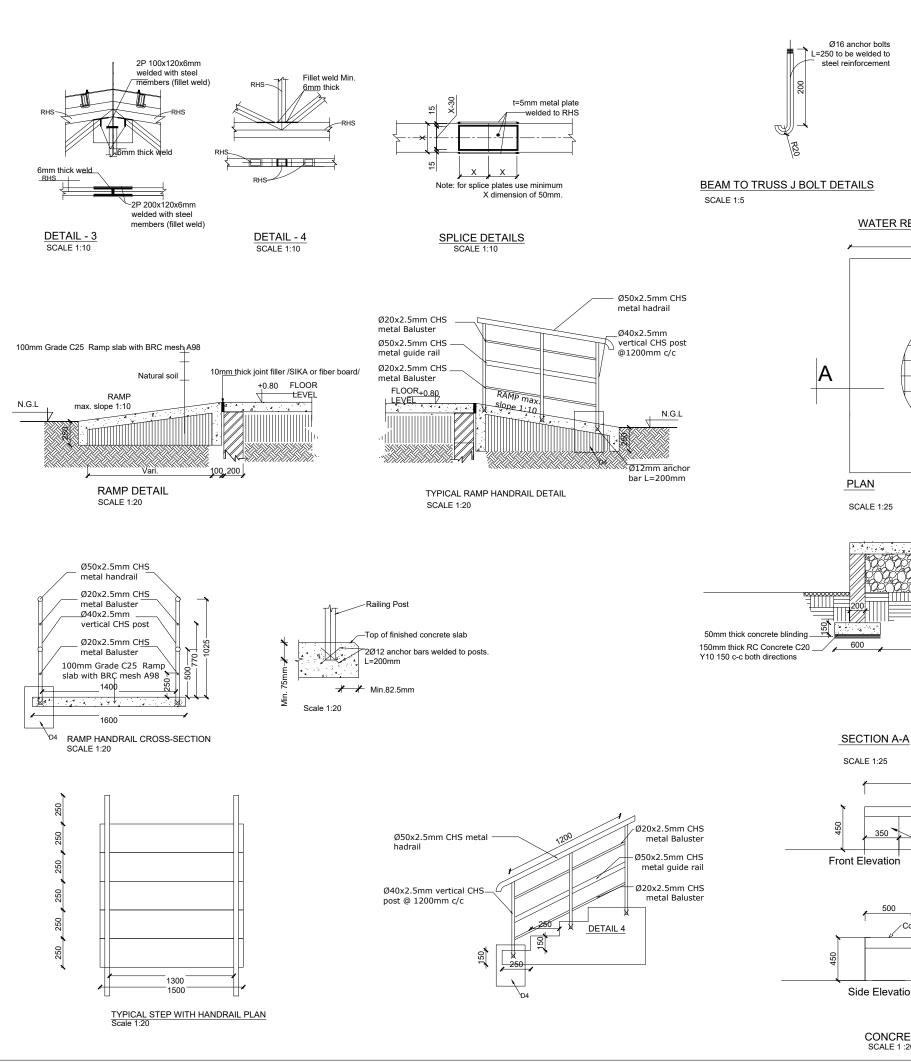
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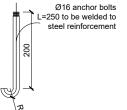


PROPOSED PRIMARY HEALTH CARE UNIT

Drawing Tittle

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Sheet #:	8/16	Scale: AS SPECIFIED
Date:	28 May 2024	Rev: 2










PURLIN TO G.I SHEET J BOLT DETAILS

SCALE 1:5

WATER RESERVOIR PLATFORM PLAN

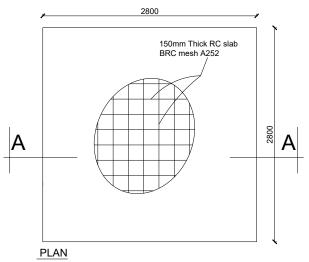

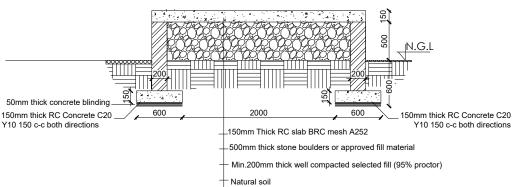

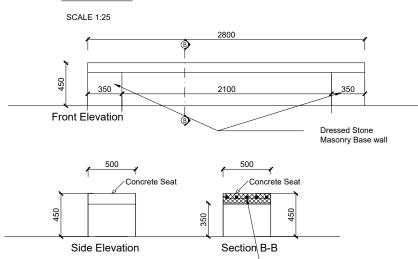

CONCRETE SEAT DETAILS SCALE 1:20



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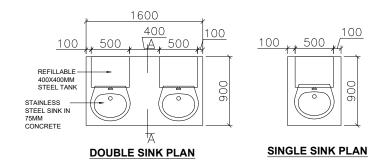



PROPOSED PRIMARY HEALTH CARE UNIT

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Ø8c/c100mm

DETAILS		T
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Checked:	F.E & G.O	Approved:
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Date:	28 May 2024	Rev: 2





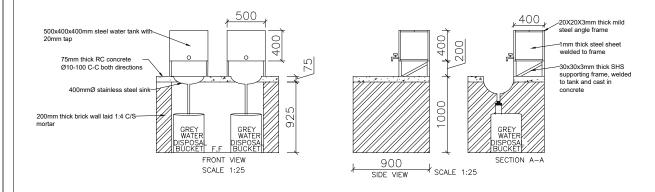



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Enhancing Community Resilience and Local Governance Project

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PROPOSED PRIMARY HEALTH CARE UNIT

Drawing Tittle

DETAILS

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Sheet #:	10/16	Scale: AS SPECIFIED
ъ.	28 May 2024	
Date:	20 May 2024	Rev: 2

DOOR SCHEDULE

DOOK SCHEDULE		
Door Name	D1	D2
Quantity	7	2
Frame material	RHS steel frame 40mm x 40mm x 2mm	RHS steel frame 40mm x 40mm x 2mm
Frame finish	Painted with 2 coats of antirust paint & 2 coats of enamel paint	Painted with 2 coats of antirust paint & 2 coats of enamel paint
Door leaf	40X40X4MM RHS surround with 40x30x2	90D opening made of 1.5mm flat metal
construction	T-sections with 5mm translucent glazing & bottom 3 panels with 1.5mm MS plate	pane
Burglar Proofing	RHS 25X25X2 mm vertical steel bars at equal intervals welded to interior of frames	
Ironmongry	Stainless steel parliament hinges, door lock with pull - push bar handle	Stainless steel parliament hinges, door lock with pull - push bar handle
Louver	0.5mm thick steel louvers welded at top to the frame. Louvers to be covered with approved mosquito net.	N/A
	000 000 000 000 000 000 000 000 000 00	1200 600 600 000 600 600 1200

WINDOW SCHEDULE

WINDOW SCILL	7				
Window Name	W1	W2	W3	W4	
Quantity	5	1	2	1	
Frame material	RHS steel frame 40mm x 40mm x 2mm	RHS steel frame 40mm x 40mm x 2mm	RHS steel frame 40mm x 40mm x 2mm	RHS steel frame 40mm x 40mm x 2mm	
Frame finish	Painted with 2 coats of antirust paint & 2 coats of enamel paint	Painted with 2 coats of antirust paint & 2 coats of enamel paint	Painted with 2 coats of antirust paint & 2 coats of enamel paint	Painted with 2 coats of antirust paint & 2 coats of enamel paint	
Glazing	5mm thick clear glass	5mm thick clear glass	5mm thick clear glass	5mm thick clear glass	
Burglar proofing	RHS 25X25X2mm vertical steel bars at equal intervals welded to interior of frames	N/A	RHS 25X25X2 mm vertical steel bars at equal intervals welded to interior side of frames	RHS 25X25X2 mm vertical steel bars at equal intervals welded to interior of frames	
Ironmongry	Stainless steel parliament hinges, window lock with bar handle	Stainless steel parliament hinges, window lock with latch	Stainless steel parliament hinges, window lock with latch	Stainless steel parliament hinges, window lock with bar handle	
Louvers	0.5mm thick steel louvers welded to RHS frame. Louver to be covered with approved mosquito net.	N/A	0.5mm thick steel louvers welded to RHS frame. Louver to be covered with approved mosquito net.	0.5mm thick steel louvers welded to RHS frame. Louver to be covered with approve mosquito net.	
	+3.50 +2.90 +1.80	+2 <u>.90</u> 1 +2 <u>.00</u> 1 600	+3.50, +2.90, +2.00, -600	+3.50) +2.90 +1.80)	
	+0.80	1200	1200	+0.80	

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Enhancing Community
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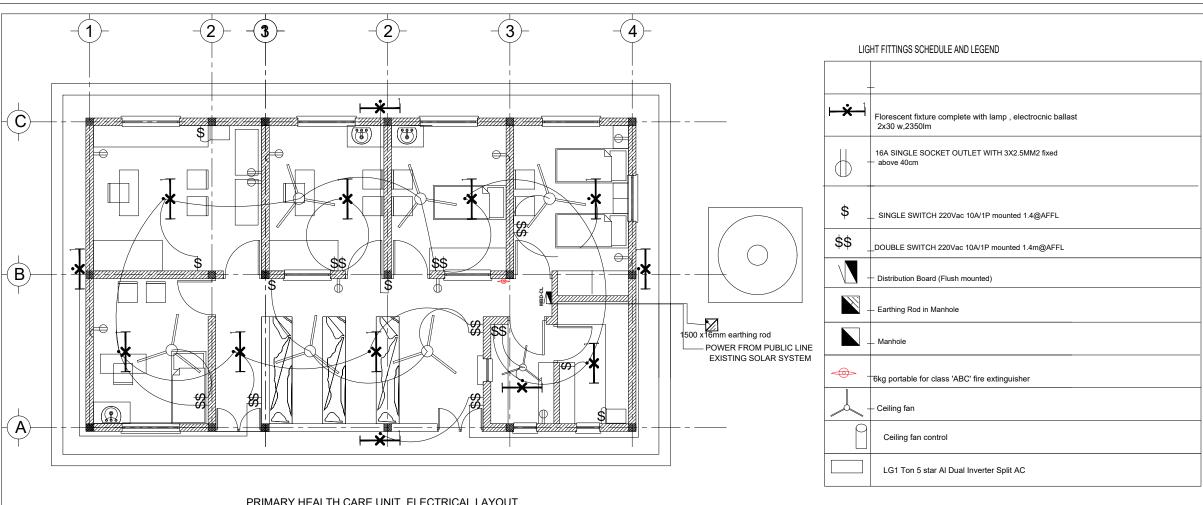


PROPOSED PRIMARY HEALTH CARE UNIT


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DOOR AND WINDOWS SCHEDULE

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Sheet #:	11/16	Scale: AS SPECIFIED
Date:	28 May 2024	Rev: 2



PRIMARY HEALTH CARE UNIT ELECTRICAL LAYOUT Sc. 1:50

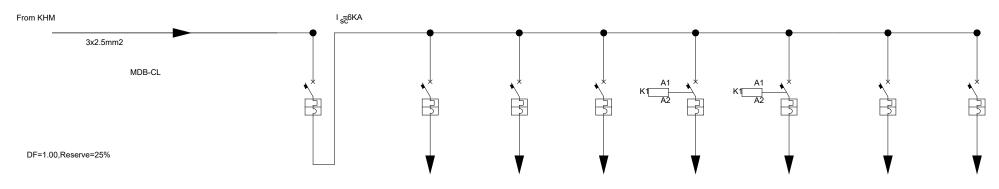

CIRCUIT NUMBER	No		1	2	3	4	5	6	7
DESCRIPTION		Main Breaker	Lighting	Lighting	Lighting	Socket	AC Socket	Ceiling fan	Spare
POWER	KW	1.26	0.36	0.36	0.36	0.4	2.8		
CURRENT	Α								
PHASE	R	R	R	R	R	R	R	R	R
VOLTAGE	V	220	220	220	220	220	220	220	220
POLES		1	1	1	1	1	1	1	1
O O O INTERRUPTING RATING	А	16	10	10	10	16	16	16	16
CABLE SIZE	mm 2	3x2.5	2x2.5	2x2.5	2x2.5	3x2.5	3x5	3x2.5	3x2.5

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PROPOSED PRIMARY HEALTH CARE UNIT

Drawing Tittle


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ELECTRICAL	LAYOUI	
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Checked:	F.E & G.O	Approved:
Sheet #:	12/16	Scale: AS SPECIFIED
Date:	28 May 2024	Rev: 2


MDB-(PRIMARY HEALTH CARE UNIT)

20A bus bar

INTERNAL WIRING DIAGRAM

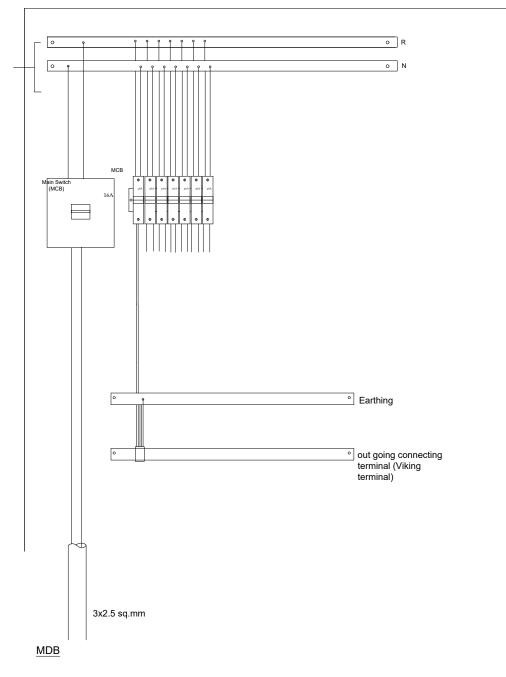

SCALE 1:50

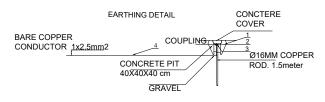


LEGEND TO EARTHING SYSTEM DETAIL

1 | MANHOI F

	WANTOLE	400 X 400 X 400mm
	DRIVIG STUD	
3	ROD TO TAPE CLAMP	
4	EARTH CONDUCTOR (bare)	1 x 2.5mmsq.

INTERCONECTION DIAGRAM

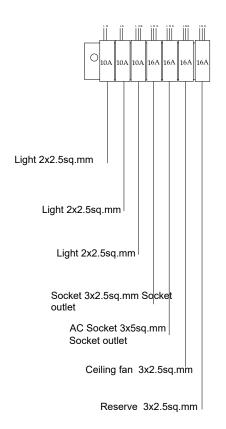

SCALE 1:20

NOTE

- 1 ALL DIMENSIONS ARE IN METERS
- 2 DIVERSITY FACTOR CALCULATED: = 0.9
- 3 ALL ELEVATIONS ARE REFEREED TO ABOVE FINISHED FLOOR LEVEL (A.F.F.L)
- 4 ALL JUNCTION BOXES ARE NOT SHOWN BUT THEY ARE INSTALLED EVERY TWO BENDS
- 5- ALL CONDUITS USED FOR LIGHTING & SOCKET OUTLETS ARE PVC Ø 16MM, AND DEPENDING ON THE NUMBER OF LINES INSIDE CONDUITS FROM JUNCTION BOX TO EVERY INDIVIDUAL POINT.
- 6- INSTALLATION ELEVATIONS ABOVE F.F. ARE @1.40M FOR SWITCH,
- @2.00M FOR KWHM, @0.50M FOR SOCKET OUTLETS. 7- CABLE TYPE FOR THE WIRING TO BE USED SHALL BE NYY 0.6/1KV
- 8- 10- ILLUMINATION LEVEL FOR EACH ROOM IS MAINTAINED AS PER ETHIOPIAN

BUILDING STANDARD CODE EBCS-10.

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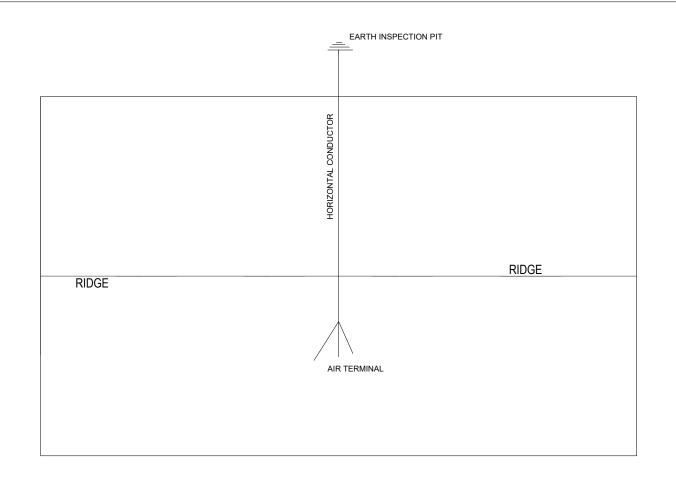
Implemented By:



PROPOSED PRIMARY HEALTH CARE UNIT


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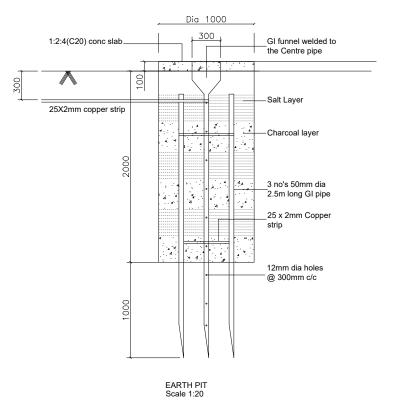
ELECTRICAL		
Designed By: H.A		Drawn by: H.A
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Date:	28 May 2024	Rev: 2



LIGHTNING PROTECTION PLAN

SCALE 1:50



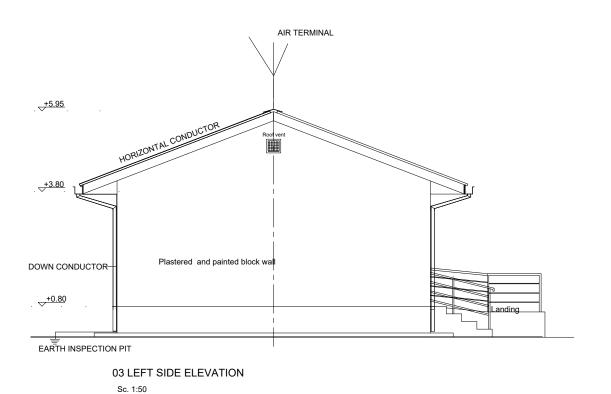





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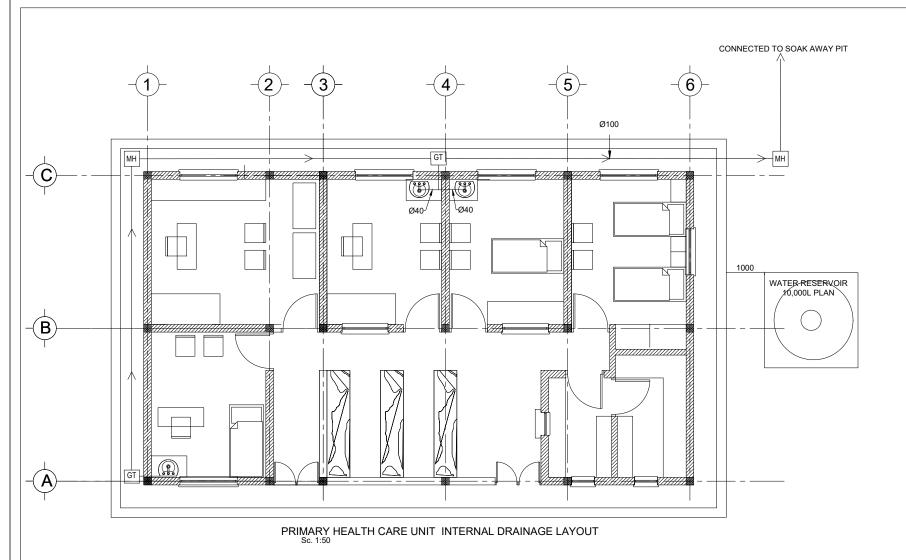


PROPOSED PRIMARY HEALTH CARE UNIT

Drawing Tittle

LIGHTNING PROTECTION LAYOUT

Designed By	7: H.A	Drawn by: H.A
Checked:	F.E & G.O	Approved:
Sheet #:	14/16	Scale: AS SPECIFIED
Date:	25 June 2024	Rev: 0



LEGEND			
=	MANHOLE	MH	1
7	GULLY TRAF	GT	2
-	HIGH LEVEL	H/L	3
[VALVE CHAMBER	VC	4
-	POLYPROPYLENE PIPE	PPR	5
=	COLD WATER SERVICE	CWS	6
	WATER METER	O WM	7
,	PUMF		8
-	OVER FLOW PIPE	OFP	9
-	FROM ABOVE	F/A	10
=	TO ABOVE	T/A	11
7	FROM BELOW	F/B	12
Ī	TO BELOW	T/B	13
:	BFV - BALL FLOAT VALVE	M.o	14
	ISOLATED VALVE (GATE VALVE	\bowtie	15
	NON-RETURN VALVE	₩	16





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Enhancing Community Resilience and Local Governance Project

Program

GOVERNMENT OF SOUTH SUDAN

Implemented By:



PROPOSED PRIMARY HEALTH CARE UNIT

Drawing Tittle

DOOR AND WINDOWS SCHEDULE

Designed By: H.A	Drawn by: H.A
Checked: F.E & G.O	Approved:
Sheet #: 15/16	Scale: AS SPECIFIED
Date: 25 June 2024	Rev: 0
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