# SANITATION FACILITIES- THREE STANCE VIP LATRINES (MALE) (BLACK COTTON)





- All dimensions are in millimeters unless otherwise stated.
   All dimensions are to checked and confirmed on site before
- commencement of any work

  Depth of pad foundation 1200mm.

  Depth of strip foundation 750mm.

- Any discrepancy or changes is to be reported to IOM site Engineer/Project manager before proceeding

Rev:	Date	Description:	Approved
	//		
	//		
	//		
	//		

### Program



GOVERNMENT OF SOUTH SUDAN

Implemented By:




PROPOSED VIP LATRINES (MALE)


BLOCK OF THREE STANCE (BLACK COTTON SOIL)

Drawing Tittle

COVER PAGE

Designed By: H.A	Drawn by: H.A
Checked: F.E & G.O	Approved:
Sheet #: 1/6	Scale: AS SPECIFIED
Date: 22 July 2024	Rev: 0

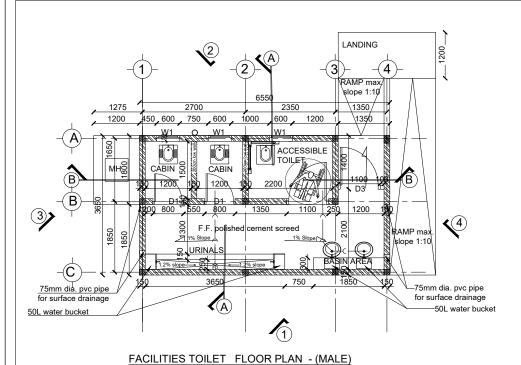

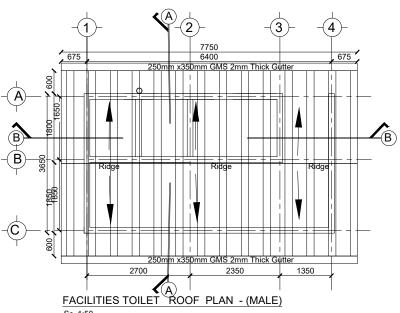



Pitch 22 5°
28 Guage Pre-painted Super V IT4sheet
- J bolt connection to Z or C-purlin
Steel Z-Purlin (See ST Drawing for details)


soil vent pipe

Mild steel in Standard sections Rafter -(See S† Drawings for detail)

Vent cap with

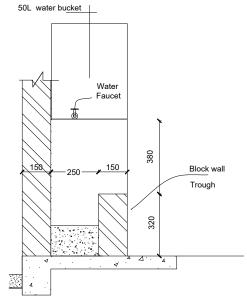

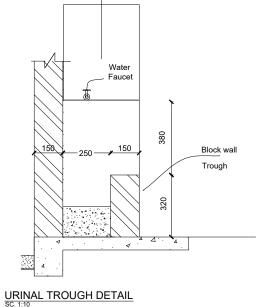

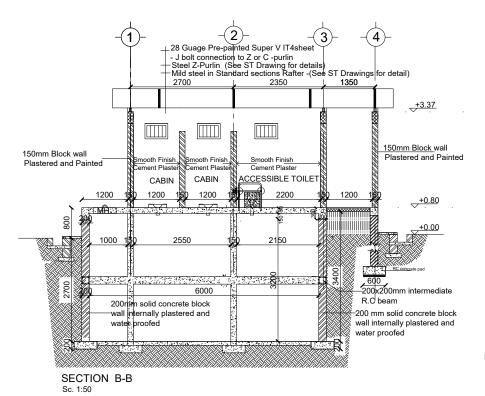

200 1175 6000


FACILITIES TOILET PIT PLAN - (MALE)

150 mm Block wall LOBBY 150 mm Block wall Plastered and Painted finish NOTE: RAISED HEIGHT SHALL BE ADJUSTED BY PROJECT ENGINEER FOR THE POTENTIAL LEVEL OF FLOODS IN THE SITES. 50mm cement screed floor finish 100mm Class 20 (1: 2 : 4) Concrete Floor slab 00mm solid concrete block wall 200mm Crushed Stone (Hardcore)/Murram internally plastered and water proofed Equivalent material approved by project Engineer
Min 500 mm thick Compacted selected fill to grade
Natural Normal soil SECTION A-A 100mm Concrete Floor slab 200mm Crused Stone (Hardcore)/ Equivalent material approved by engineer
- Natural Normal soil

+4.37

150 mm Louvers

50L water bucket~

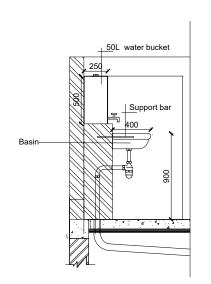

HAND WASH BASIN DETAIL SCALE -1:25



- All dimensions are in millimeters unless otherwise stated.
   All dimensions are to checked and confirmed on site before
- commencement of any work
- Depth of pad foundation 1200mm. Depth of strip foundation 750mm.
- Any discrepancy or changes is to be reported to IOM site Engineer/Project manager before proceeding

Rev:	Date	Description:	Approved
	//		
	//		
	//		
	//		

Program



Enhancing Community Resilience and Local Governance Project

GOVERNMENT OF SOUTH SUDAN

Implemented By:




PROPOSED VIP LATRINES (MALE)

A BLOCK OF THREE STANCE (BLACK COTTON SOIL)

Drawing Tittle


FLOOR PLAN, ROOF PLAN, SECTIONS


Designed By	y: H.A	Drawn by: H.A
Checked:	F.E & G.O	Approved:
Sheet #:	2/6	Scale: AS SPECIFIED
Date:	22 July 2024	Rev: 0

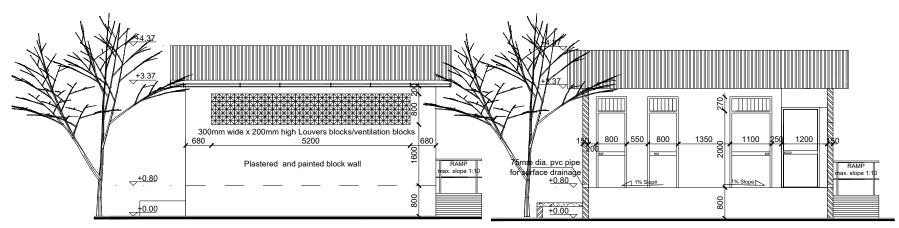

## FRONT SIDE ELEVATION 1

FRONT SIDE ELEVATION 1A (without front wall)

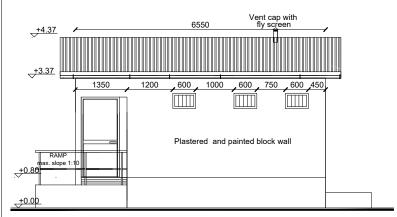

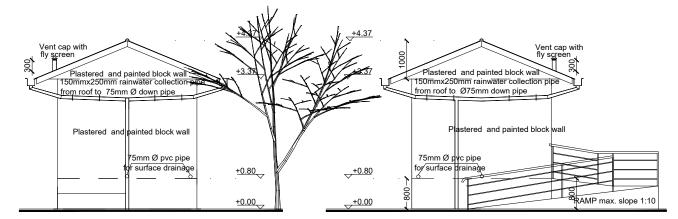


**REAR ELEVATION 2 SIDE ELEVATION 3** 

## DOOR SCHEDULE

Door Name	D1	D2	D3
Quantity	2	1	1
Frame material	RHS steel frame 40mm x 40mm x 2mm	RHS steel frame 40mm x 40mm x 2mm	RHS steel frame 40mm x 40mm x 2mm
Frame finish	Painted with 2 coats of antirust paint & 2 coats of enamel paint	Painted with 2 coats of antirust paint & 2 coats of enamel paint	Painted with 2 coats of antirust paint & 2 coats of enamel paint
Door leaf construction	90D opening made of 1.5mm flat metal pane	90D opening made of 1.5mm flat metal pane	90D opening made of 1.5mm flat metal pane
Burglar Proofing		RHS 25X25X2 mm vertical steel bars at equal intervals welded to frames on the interior side	RHS 25X25X2 mm vertical steel bars at equal intervals welded to frames on the interior side
Ironmongry	stainless steel pull-push bar handle	stainless steel pull-push bar handle	stainless steel pull-push bar handle
Louver	0.5mm thick steel louvers welded at top to the frame.	0.5mm thick steel louvers welded at top to the frame.	
	900 1100 270	1100 2270	1100 190

### WINDOW SCHEDULE

WINDOW SCHEDULE				
Window Name	W1			
Quantity	3			
Frame material	RHS steel frame 40mm x 40mm x 2mm			
Frame finish	Painted with 2 coats of antirust paint & 2 coats of enamel paint			
Burglar proofing				
Louvers	Steel Louver			
	+2.27 + +1.87 + 000 + 000			
	+0.00			

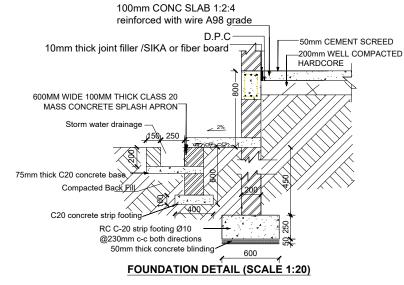

SIDE ELEVATION 4

100mm Conc Cover 1:2:4 Reinforced With Ere A98 Grade DETAIL FOR MAN HÓLE SCALE 1:20





- All dimensions are in millimeters unless otherwise stated. All dimensions are to checked and confirmed on site before
- commencement of any work
  Depth of pad foundation 1200mm.
  Depth of strip foundation 750mm.
- Any discrepancy or changes is to be reported to IOM site Engineer/Project manager before proceeding

Rev:	Date	Description:	Approved
	//		
	//		
	//		
	//		





GOVERNMENT OF SOUTH SUDAN

Implemented By:



Project:

PROPOSED VIP LATRINES (MALE)

A BLOCK OF THREE STANCE (BLACK COTTON SOIL) Drawing Tittle

ELEVATIONS AND DETAILS

Designed By	: H.A	Drawn by: H.A
Checked:	F.E & G.O	Approved:
Sheet #:	3/6	Scale: AS SPECIFIED
Date:	22 July 2024	Rev: 0

# STRUCTURAL NOTES:

- Building shall be founded on load bearing stone masonry wall having a depth of 750mm and pad foundation depth of 1200mm from the natural ground level with bottom of excavation compacted prior to laying the foundation wall.
- H) Stone masonry foundation shall be placed on the natural black cotton soil and achieve a minimum bearing capacity of 100 KN/m2
- III) Foundation trench excavation to be approved by the Engineer prior to the construction of the stone masonry foundation.
- Material Specification
- A) Grade of Structural Concrete

C-25 (Cube characteristics strength of 25 MPa mix ratio 1:1.5:3) for columns and beams;

C-20 (Cube characteristics strength of 20 MPa mix ratio 1:2:4) for floor slab)

Concrete reinforcement bar

Grade 460 (Characteristics yield strength of fyk = 460 MPa)

C) Steel hollow section for roofing system, verandah column and plates

Grade C: Tensile Strength = 375 Mpa

Yield Strength = 275 Mpa

D) Grade of Bolts

Grade 4.6: Yield Strength = 240 Mpa

Tensile Strength = 400 Mpa

- **Durability Requirements**
- Concrete Cover to Reinforcement
  - Floor slabs: 25mm.
  - Beams: 25mm
  - Columns: 25mm
  - All foundations (below the ground level): 50mm
- Protection of steel work
  - Surface preparation by blast cleaning, pickling process or where approved by wire brushing
  - Application of one coat of an approved pre-fabrication fabrication primer e.g. Zinc
  - Two coats of an approved paint system to be proposed by Architect, one applied at shop and the other on site after erection.





- All dimensions are in millimeters unless otherwise stated.
  All dimensions are to checked and confirmed on site before
- commencement of any work
- Depth of pad foundation 1200mm
- Depth of strip foundation 750mm
- Any discrepancy or changes is to be reported to IOM site Engineer/Project manager before proceeding

Rev:	Date	Description:	Approved
	//		
	//		
	//		
	//		

#### Program



GOVERNMENT OF SOUTH SUDAN

Implemented By:




PROPOSED VIP LATRINES (MALE)

A BLOCK OF THREE STANCE (BLACK COTTON SOIL

STRUCTURAL NOTES

Designed By	: H.A	Drawn by: H.A
Checked:	F.E & G.O	Approved:
Sheet #:	4/6	Scale: AS SPECIFIED
Date:	22 July 2024	Rev: 0

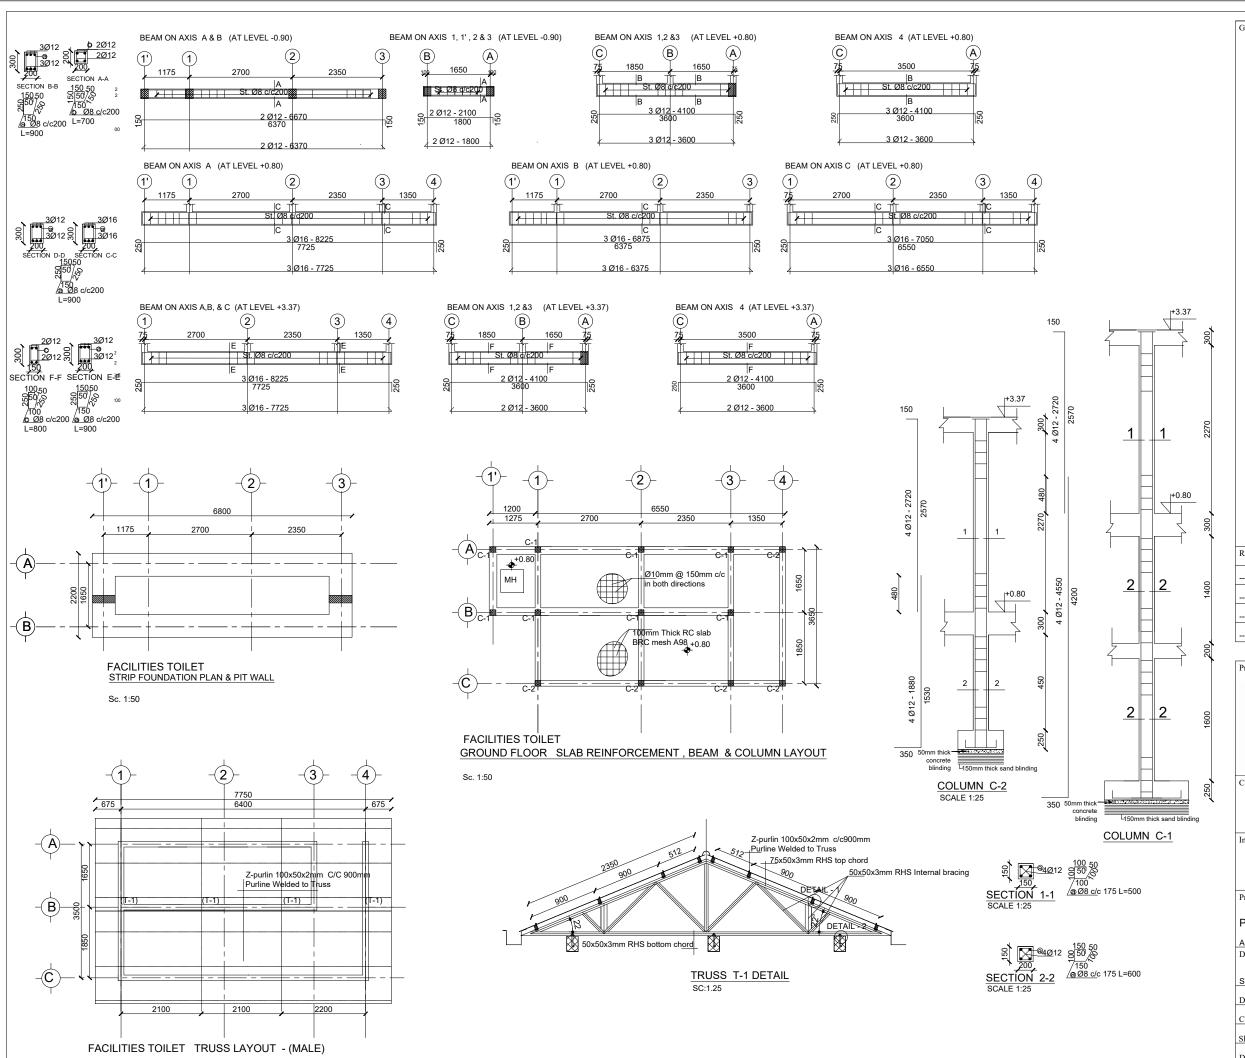



- All dimensions are in millimeters unless otherwise stated. All dimensions are to checked and confirmed on site before
- commencement of any work
- Depth of pad foundation 1200mm. Depth of strip foundation 750mm.
- Any discrepancy or changes is to be reported to IOM site Engineer/Project manager before proceeding

Rev:	Date	Description:	Approved
	//		
	//		
	//		
	1.1		





Enhancing Community Resilience and Local Governance Project

GOVERNMENT OF SOUTH SUDAN

Implemented By:




Project:

PROPOSED VIP LATRINES (MALE)

A BLOCK OF THREE STANCE (BLACK COTTON SOIL)

Drawing Tittle

SI	RUCTURAL DETAILS	
Des	signed By: H.A	Drawn by: H.A
Che	ecked: F.E & G.O	Approved:
She	et #: 5/6	Scale: AS SPECIFIED
Dat	e: 22 July 2024	Rev: 0

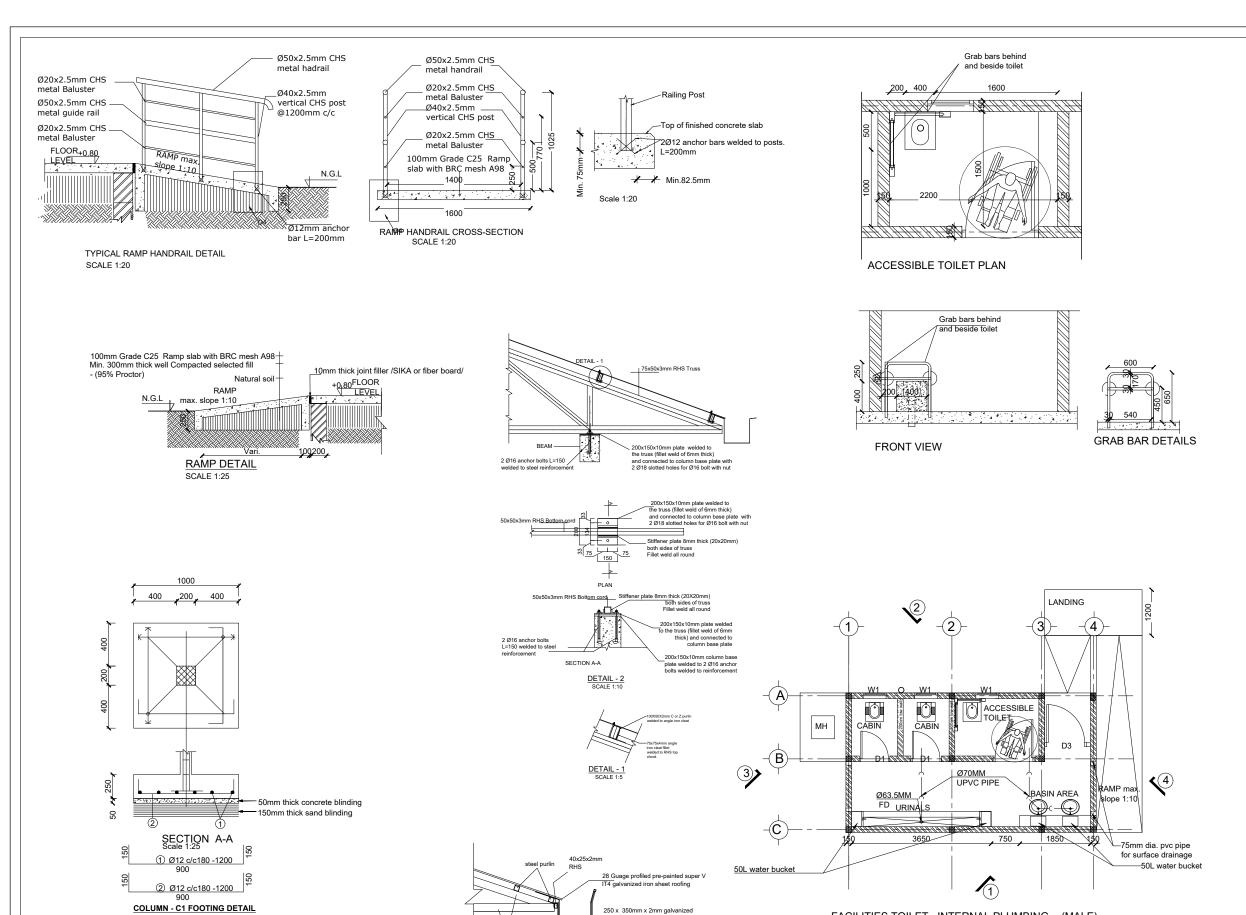

250 x 350mm x 2mm galvanized

metal sheet gutter

Detail 01: Overhung Gutter Detail

total Length = 1065mm sc. 1:16

20mm x 6mm thick metalic support bracket set at 2000mm spacing

SCALE 1:20



- All dimensions are in millimeters unless otherwise stated.
  All dimensions are to checked and confirmed on site before
- commencement of any work
  Depth of pad foundation 1200mm. Depth of strip foundation 750mm.
- Any discrepancy or changes is to be reported to IOM site Engineer/Project manager before proceeding

Rev:	Date	Description:	Approved
	//		
	//		
	//		
	//		



Enhancing Community Resilience and Local Governance Project

Program

GOVERNMENT OF SOUTH SUDAN

Implemented By:



Project:

FACILITIES TOILET INTERNAL PLUMBING - (MALE)

PROPOSED VIP LATRINES (MALE)

A BLOCK OF THREE STANCE (BLACK COTTON SOIL)

Drawing Tittle

SI	STRUCTURAL DETAILS	
Des	igned By: H.A	Drawn by: H.A
Che	cked: F.E & G.O	Approved:
She	et #: 6/6	Scale: AS SPECIFIED
Dat	e: 22 July 2024	Rev: 0

# SANITATION FACILITIES- THREE STANCE VIP LATRINES (FEMALE) (BLACK COTTON)





- All dimensions are in millimeters unless otherwise stated.
   All dimensions are to checked and confirmed on site before

- An dimensions are to checked and confirmed on site before commencement of any work
   Depth of pad foundation 1200mm.
   Depth of strip foundation 750mm.
   Any discrepancy or changes is to be reported to IOM site Engineer/Project manager before proceeding

Rev:	Date	Description:	Approved
	//		
	//		
	//		
	//		

Program



GOVERNMENT OF SOUTH SUDAN

Implemented By:




PROPOSED VIP LATRINES (FEMALE)


BLOCK OF THREE STANCE (BLACK COTTON SOIL)


Drawing Tittle


COVER PAGE

Designed By:	H.A	Drawn by: H.A
Checked:	F.E & G.O	Approved:
Sheet #:	1/5	Scale: AS SPECIFIED
Date:	22 July 2024	Rev: 1

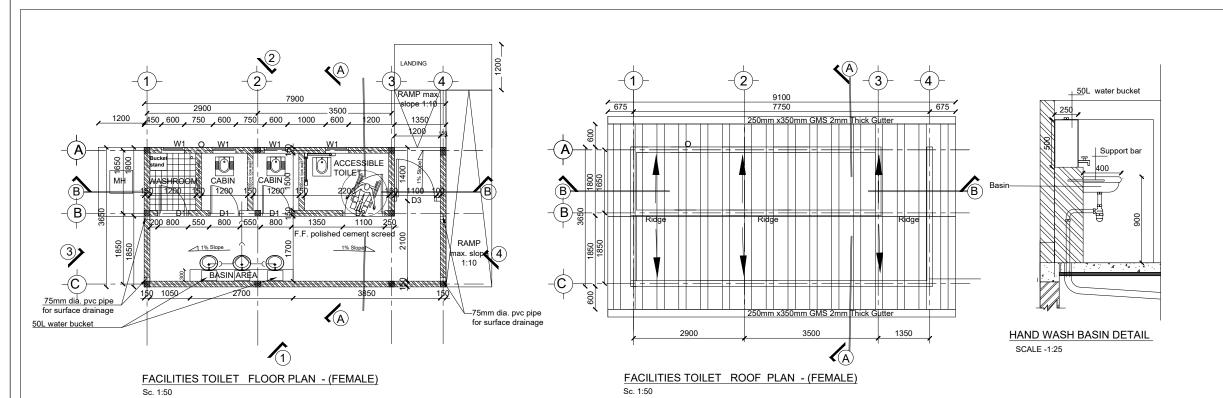

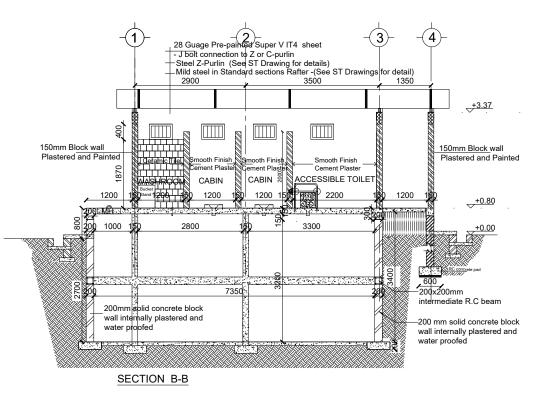

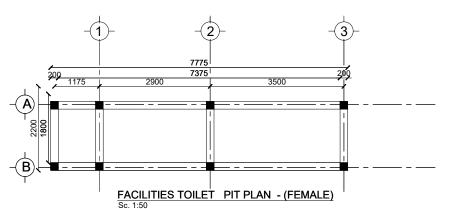

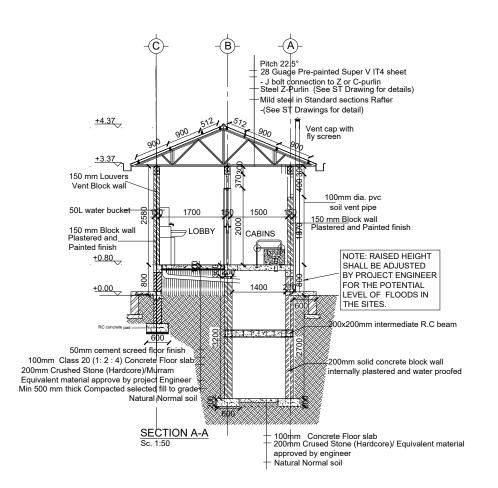

# GENERAL NOTES:



- All dimensions are in millimeters unless otherwise stated.
  All dimensions are to checked and confirmed on site before
- commencement of any work
- Depth of pad foundation 1200mm Depth of strip foundation 750mm.
- Any discrepancy or changes is to be reported to IOM site Engineer/Project manager before proceeding

Rev:	Date	Description:	Approved
	//		
	//		
	//		
	//		

### Program



Enhancing Community Resilience and Local Governance Project

GOVERNMENT OF SOUTH SUDAN

Implemented By:




Project:

PROPOSED VIP LATRINES (FEMALE)

A BLOCK OF THREE STANCE AND WASHROOM (BLACK COTTON SOIL) Drawing Tittle


FLOOR PLAN, ROOF PLAN, SECTIONS


Designed By:	H.A	Drawn by: H.A
Checked:	F.E & G.O	Approved:
Sheet #:	2/5	Scale: AS SPECIFIED
Date:	22 July 2024	Rev: 0

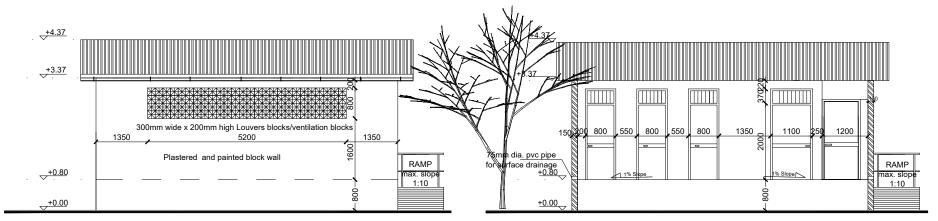

## FRONT SIDE ELEVATION 1

FRONT SIDE ELEVATION 1A (without front wall)

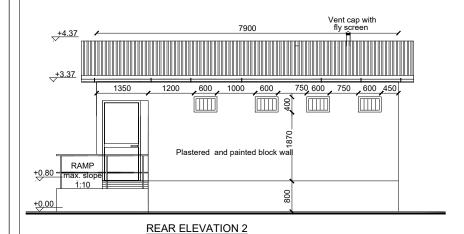

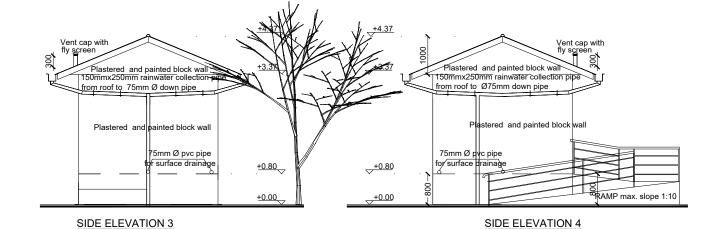



# DOOR SCHEDULE

Door Name	D1	D2	D3
Quantity	3	1	1
Frame material	RHS steel frame 40mm x 40mm x 2mm	RHS steel frame 40mm x 40mm x 2mm	RHS steel frame 40mm x 40mm x 2mn
Frame finish	Painted with 2 coats of antirust paint & 2 coats of enamel paint	Painted with 2 coats of antirust paint & 2 coats of enamel paint	Painted with 2 coats of antirust paint & 2 coats of enamel paint
Door leaf construction	90D opening made of 1.5mm flat metal pane	90D opening made of 1.5mm flat metal pane	90D opening made of 1.5mm flat metal pane
Burglar Proofing	RHS 25X25X2 mm vertical steel bars at equal intervals welded to frames on the interior side	RHS 25X25X2 mm vertical steel bars at equal intervals welded to frames on the interior side	RHS 25X25X2 mm vertical steel bars at equal intervals welded to frames on the interior side
Ironmongry	stainless steel pull-push bar handle	stainless steel pull-push bar handle	stainless steel pull-push bar handle
Louver	0.5mm thick steel louvers welded at top to the frame.	0.5mm thick steel louvers welded at top to the frame.	
	900 1100 270	1100 2200	1100 100

#### WINDOW SCHEDULE

Window Name	W1	
Quantity	4	
Frame material	RHS steel frame 40mm x 40mm x 2mm	
Frame finish	Painted with 2 coats of antirust paint & 2 coats of enamel paint	
Burglar proofing		
Louvers	Steel Louver	
	+2.27 +   600 00 00 00 00 00 00 00 00 00 00 00 00	
	+0,00	

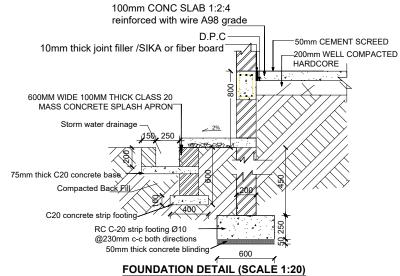

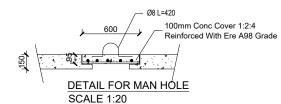





- All dimensions are in millimeters unless otherwise stated.
  All dimensions are to checked and confirmed on site before
- commencement of any work
  Depth of pad foundation 1200mm.
- Depth of strip foundation 750mm.
- Any discrepancy or changes is to be reported to IOM site Engineer/Project manager before proceeding

ev:	Date	Description:	Approved
	//		
	//		
	//		
	//		

## Program



GOVERNMENT OF SOUTH SUDAN

Implemented By:




Project:


PROPOSED VIP LATRINES (FEMALE)

A BLOCK OF THREE STANCE AND WASHROOM (BLACK COTTON SOIL) Drawing Tittle

ELEVATIONS AND DETAILS

Drawn by: H.A
Approved:
Scale: AS SPECIFIED
Rev: 0

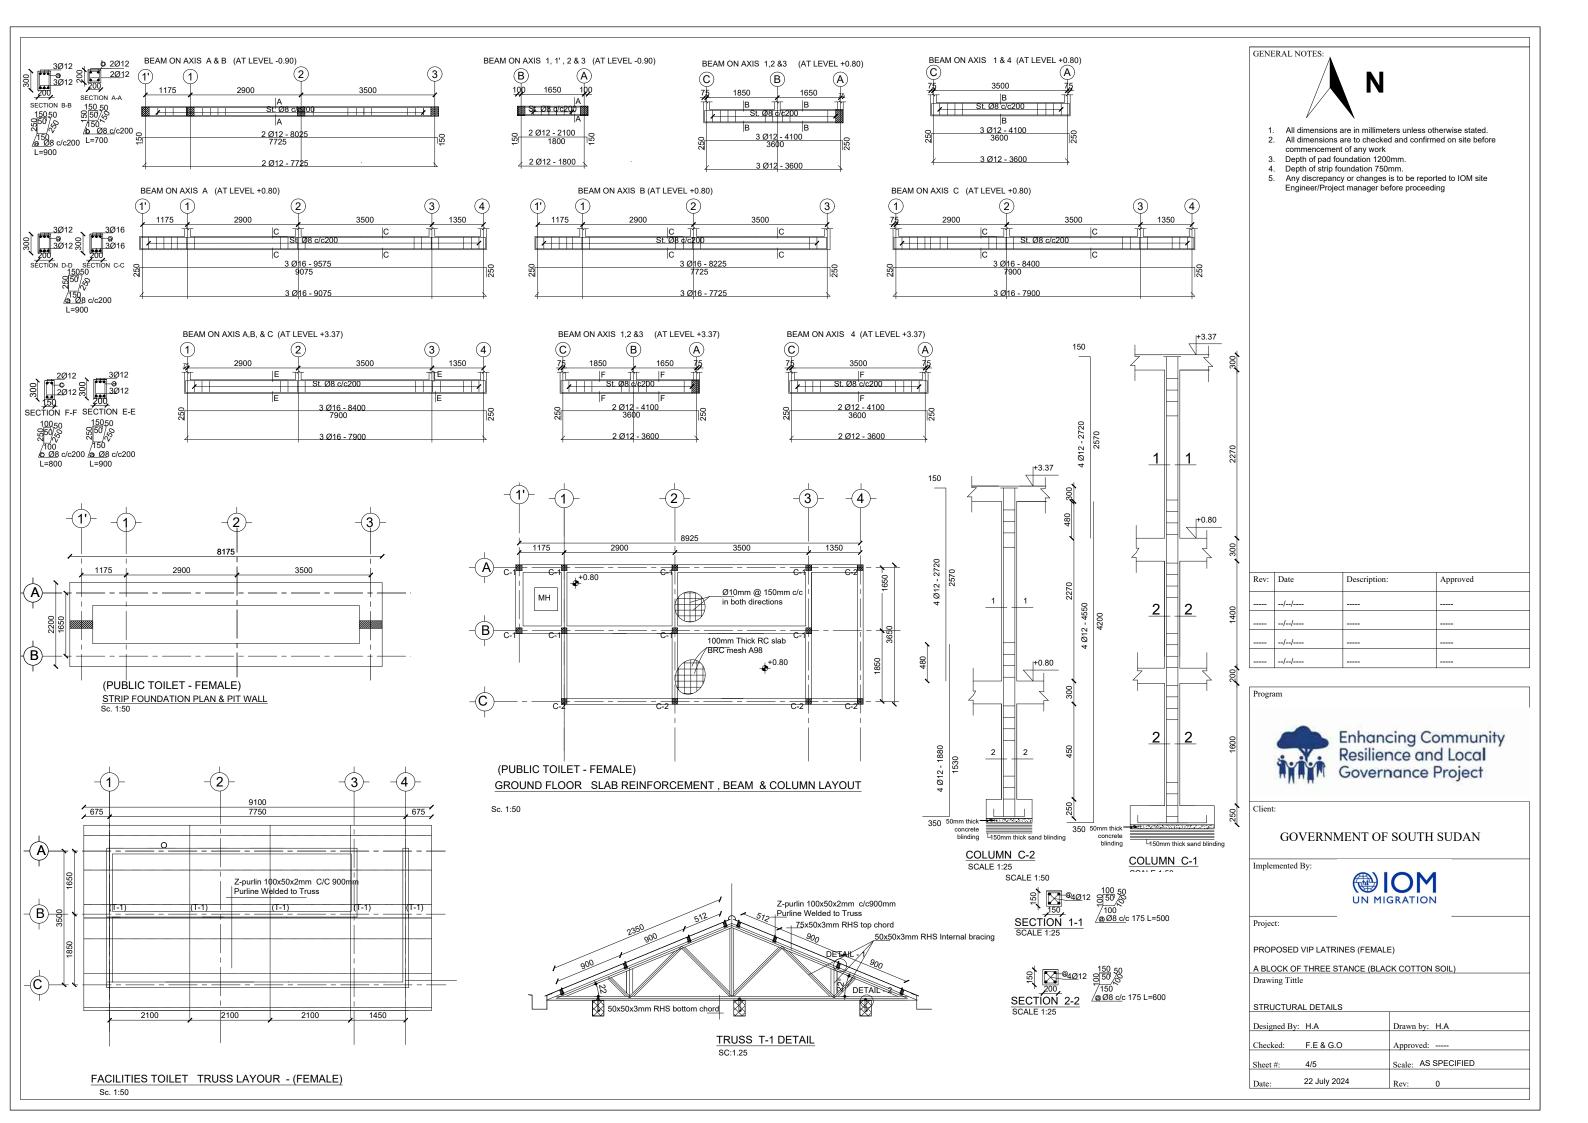

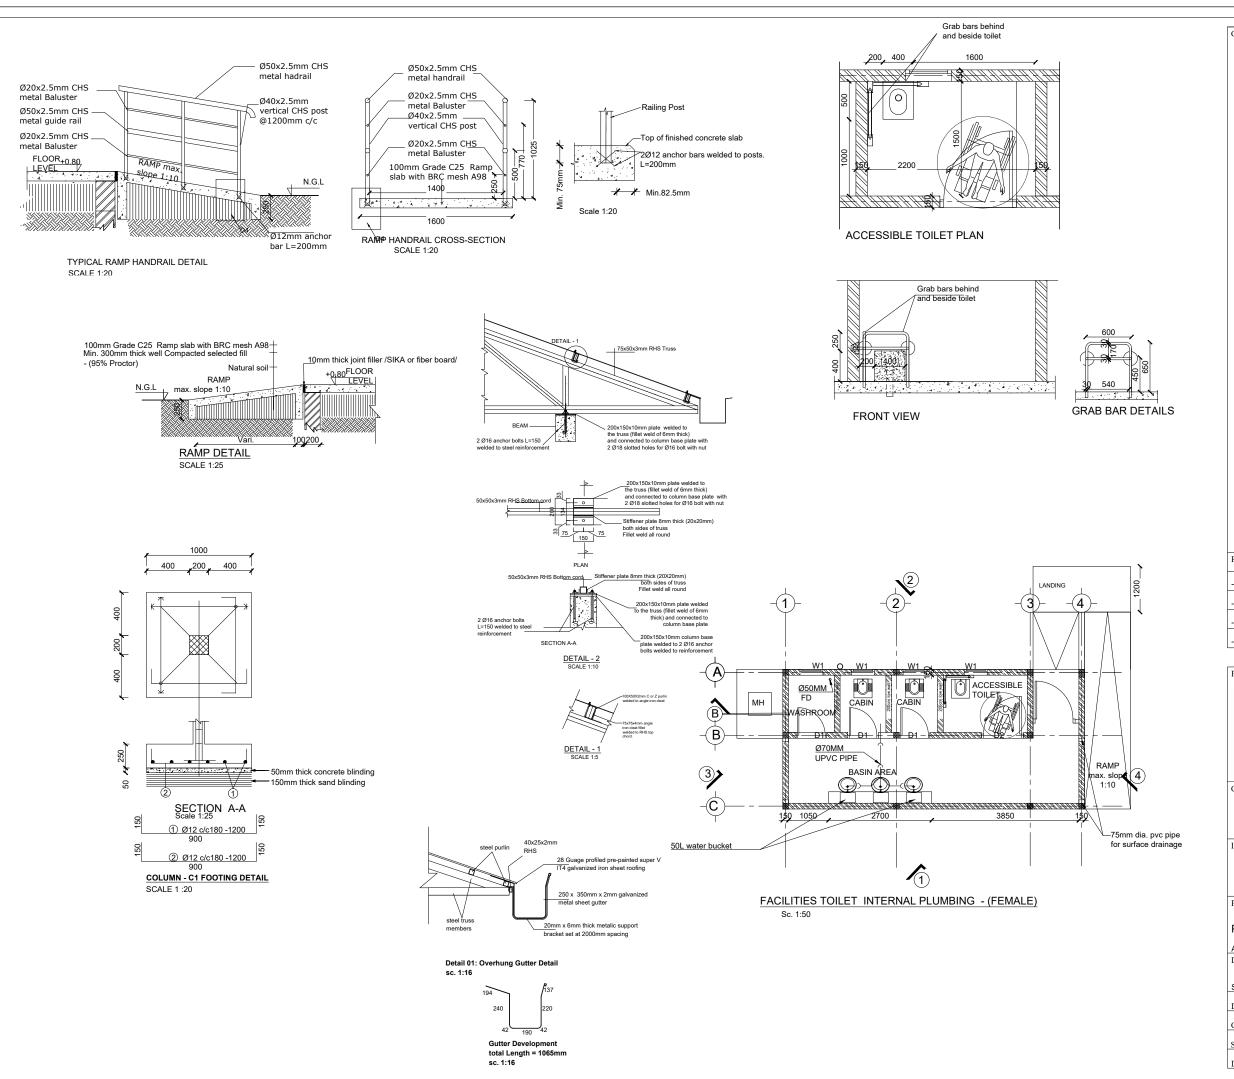



- All dimensions are in millimeters unless otherwise stated.
  All dimensions are to checked and confirmed on site before
- commencement of any work
  Depth of pad foundation 1200mm. Depth of strip foundation 750mm.
- Any discrepancy or changes is to be reported to IOM site Engineer/Project manager before proceeding

Rev:	Date	Description:	Approved
	//		
	//		
	//		
	//		





Enhancing Community Resilience and Local Governance Project

GOVERNMENT OF SOUTH SUDAN

Implemented By:



Project:

PROPOSED VIP LATRINES (FEMALE)

A BLOCK OF THREE STANCE (BLACK COTTON SOIL)

Drawing Tittle

SI	STRUCTURAL DETAILS	
De	signed By: H.A	Drawn by: H.A
Ch	ecked: F.E & G.O	Approved:
She	et #: 5/5	Scale: AS SPECIFIED
Da	e: 22 July 2024	Rev: 0