SANITATION FACILITIES - A BLOCK OF TWO STANCE VIP LATRINES (MALE) (NORMAL SOILS)

GENERAL NOTES:



- All dimensions are in millimeters unless otherwise stated.
 All dimensions are to checked and confirmed on site before
- commencement of any work.
 Written dimensions overrides scaled dimensions.
 Depth of pad foundation 800mm.
 Depth of strip foundation 600mm.

- Any discrepancy or changes is to be reported to IOM site Engineer/Project manager before proceeding

Rev:	Date	Description:	Approved
	//		
	//		
	//		
	//		

Program



GOVERNMENT OF SOUTH SUDAN

Implemented By:




PROPOSED VIP LATRINES (MALE)


A BLOCK OF TWO STANCE (NORMAL SOIL)


Drawing Tittle

COVER PAGE


Designed By:	H.A	Drawn by: H.A
Checked:	F.E & G.O	Approved:
Sheet #:	1/6	Scale: AS SPECIFIED
Date:	22 July 2024	Rev: 0

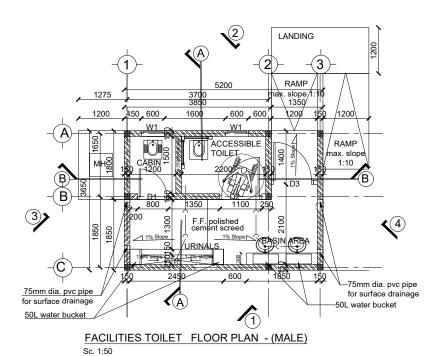

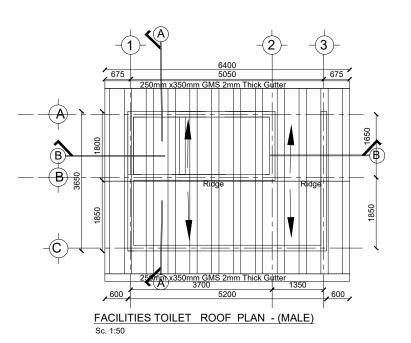


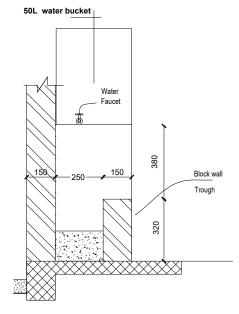



URINAL TROUGH DETAIL
SC. 1:10

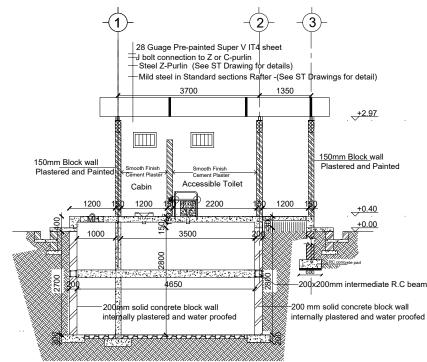

SECTION B-E

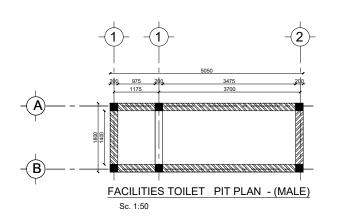

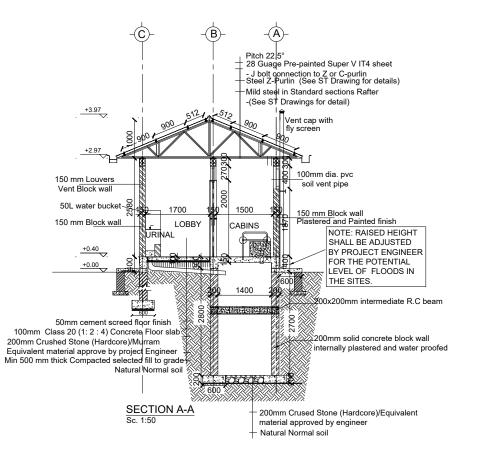

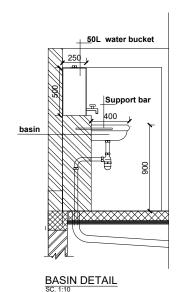

- -----

Description:

Approved

Program

Rev: Date

GENERAL NOTES:

All dimensions are in millimeters unless otherwise stated.

2. All dimensions are to checked and confirmed on site before

Any discrepancy or changes is to be reported to IOM site Engineer/Project manager before proceeding

commencement of any work.
Written dimensions overrides scaled dimensions.

Depth of pad foundation 800mm. Depth of strip foundation 600mm.



Client

GOVERNMENT OF SOUTH SUDAN

Implemented B



Project:


PROPOSED VIP LATRINES (MALE)

A BLOCK OF TWO STANCE (NORMAL SOIL)

Drawing Tittle


FLOOR PLAN, ROOF PLAND AND SECTIONS

Designed By	: H.A	Drawn by: H.A
Checked:	F.E & G.O	Approved:
Sheet #:	2/6	Scale: AS SPECIFIED
Date:		Rev:

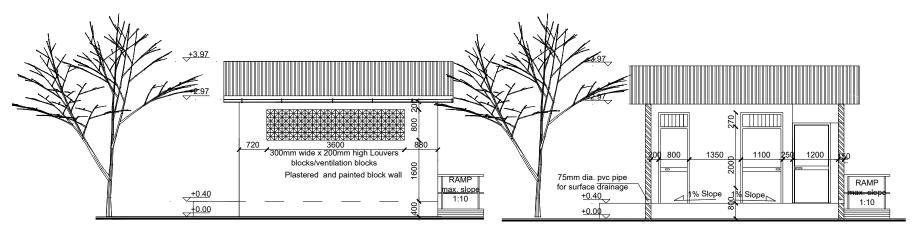

FRONT SIDE ELEVATION 1

FRONT SIDE ELEVATION 1A (without front wall)

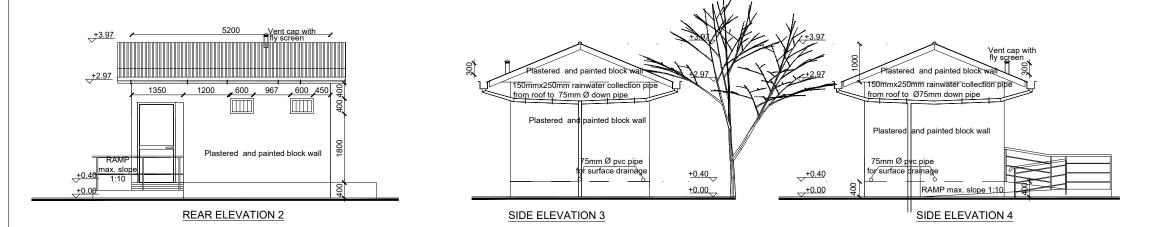



DOOR SCHEDULE

Door Name	D1	D2	D3
Quantity	1	1	1
Frame material	RHS steel frame 40mm x 40mm x 2mm	RHS steel frame 40mm x 40mm x 2mm	RHS steel frame 40mm x 40mm x 2mi
Frame finish		Painted with 2 coats of antirust paint & 2 coats of enamel paint	Painted with 2 coats of antirust paint & 2 coats of enamel paint
Door leaf construction	90D opening made of 1.5mm flat metal pane	90D opening made of 1.5mm flat metal pane	90D opening made of 1.5mm flat metal pane
Burglar Proofing		RHS 25X25X2 mm vertical steel bars at equal intervals welded to frames on the interior side	RHS 25X25X2 mm vertical steel bars a equal intervals welded to frames on the interior side
Ironmongry	stainless steel pull-push bar handle	stainless steel pull-push bar handle	stainless steel pull-push bar handle
Louver	0.5mm thick steel louvers welded at top to the frame.	0.5mm thick steel louvers welded at top to the frame.	
	900 1100 270	1100 2270	1100 100

WINDOW SCHEDULE

Window Name Quantity Frame material	W1 2 RHS steel frame 40mm x 40mm		
Frame finish	x 2mm Painted with 2 coats of antirust paint & 2 coats of enamel paint		
Burglar proofing			
Louvers	Steel Louver		
	+2.27 ± 600 + 0.081		
	+0.00		

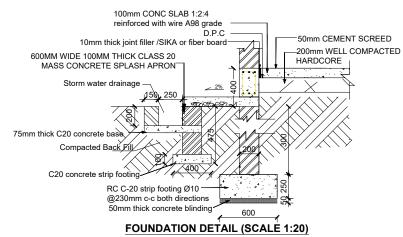

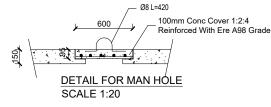



- All dimensions are in millimeters unless otherwise stated.
- 2. All dimensions are to checked and confirmed on site before
- commencement of any work.
 Written dimensions overrides scaled dimensions.
- Depth of pad foundation 800mm.
 Depth of strip foundation 600mm.
- Any discrepancy or changes is to be reported to IOM site Engineer/Project manager before proceeding

Rev:	Date	Description:	Approved

Program



GOVERNMENT OF SOUTH SUDAN



PROPOSED VIP LATRINES (MALE)

A BLOCK OF TWO STANCE (NORMAL SOIL)

Drawing Tittle

FLOOR PLAN, ROOF PLAND AND SECTIONS

Designed By: H.A	Drawn by: H.A
Checked: F.E & G.0	Approved:
Sheet #: 3/6	Scale: AS SPECIFIED
Date:	Rev: 0

STRUCTURAL NOTES:

- Building shall be founded on load bearing stone masonry wall having a depth of 600mm and pad foundation 800mm from the natural ground level with bottom of excavation compacted prior to laying the foundation wall.
- II) Stone masonry foundation shall be placed on the natural black cotton soil and achieve a minimum bearing capacity of 100 KN/m2.
- III) Foundation trench excavation to be approved by the Engineer prior to the construction of the stone masonry foundation.
- Material Specification
- A) Grade of Structural Concrete

C-25 (Cube characteristics strength of 25 MPa, mix ratio 1:1.5:3) for columns and beams;

C-20 (Cube characteristics strength of 20 MPa, mix ratio 1:2:4) for floor slab)

Concrete reinforcement bar

Grade 460 (Characteristics yield strength of fyk = 460 MPa)

C) Steel hollow section for roofing system, verandah column and plates

Grade C: Tensile Strength = 375 Mpa

Yield Strength = 275 Mpa

D) Grade of Bolts

Grade 4.6: Yield Strength = 240 Mpa

Tensile Strength = 400 Mpa

- **Durability Requirements**
- Concrete Cover to Reinforcement
 - Floor slabs: 25mm.
 - Beams: 25mm
 - Columns: 25mm
 - All founfation (below the ground level): 50mm
- Protection of steel work
 - Surface preparation by blast cleaning, pickling process or where approved by wire brushing
 - Application of one coat of an approved pre-fabrication fabrication primer e.g. Zinc
 - Two coats of an approved paint system to be proposed by Architect, one applied at shop and the other on site after erection.

GENERAL NOTES



- All dimensions are in millimeters unless otherwise stated All dimensions are to checked and confirmed on site before
- commencement of any work.
 Written dimensions overrides scaled dimensions

- Depth of pad foundation 800mm.
 Depth of strip foundation 600mm.
- Any discrepancy or changes is to be reported to IOM site Engineer/Project manager before proceeding

Rev:	Date	Description:	Approved
	//		
	//		
	//		
	//		

Program



GOVERNMENT OF SOUTH SUDAN

Implemented By:




PROPOSED VIP LATRINES (MALE)

A BLOCK OF TWO STANCE (NORMAL SO

Drawing Tittle

STRUCTURAL NOTES

SINUCIUN	STRUCTURAL NOTES		
Designed By	: H.A	Drawn by: H.A	
Checked:	F.E & G.O	Approved:	
Sheet #:	4/6	Scale: AS SPECIFIED	
Date:	22 July 2024	Rev: 0	

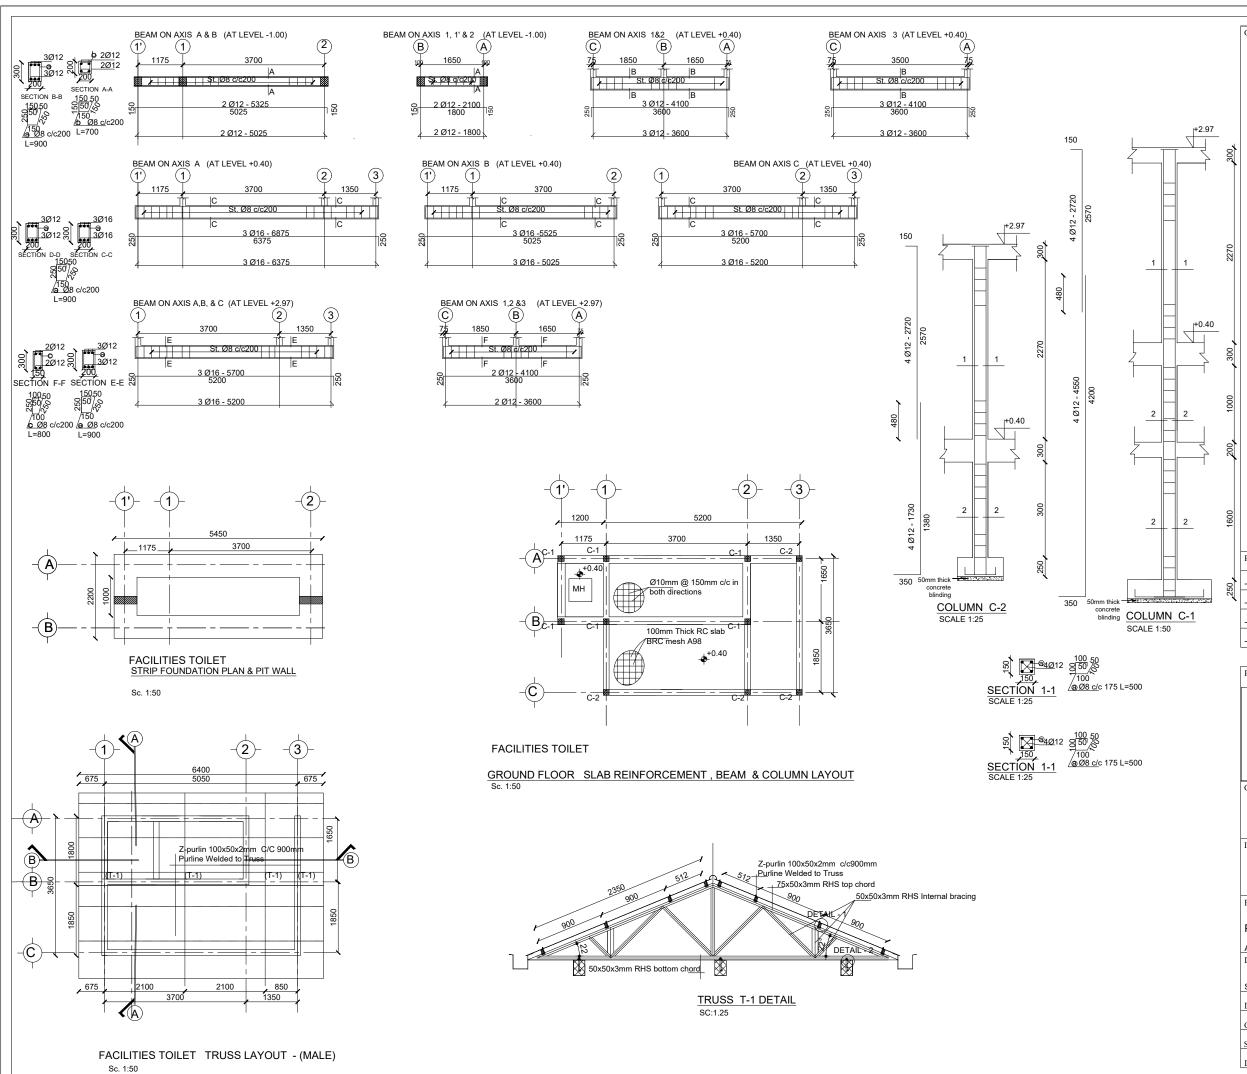



- All dimensions are in millimeters unless otherwise stated.
 All dimensions are to checked and confirmed on site before
- commencement of any work.
 Written dimensions overrides scaled dimensions.
- Depth of pad foundation 800mm. Depth of strip foundation 600mm.
- Any discrepancy or changes is to be reported to IOM site Engineer/Project manager before proceeding

Rev: Date Description: --/--/-----/--/----

Program



Enhancing Community Resilience and Local Governance Project

GOVERNMENT OF SOUTH SUDAN





PROPOSED VIP LATRINES (MALE)

A BLOCK OF TWO STANCE (NORMAL SOIL

Drawing Tittle

STRUCTURAL DETAILS		
Designed By	y: H.A	Drawn by: H.A
Checked:	F.E & G.O	Approved:
Sheet #:	5/6	Scale: AS SPECIFIED
Date:	22 July 2024	Rev: 0

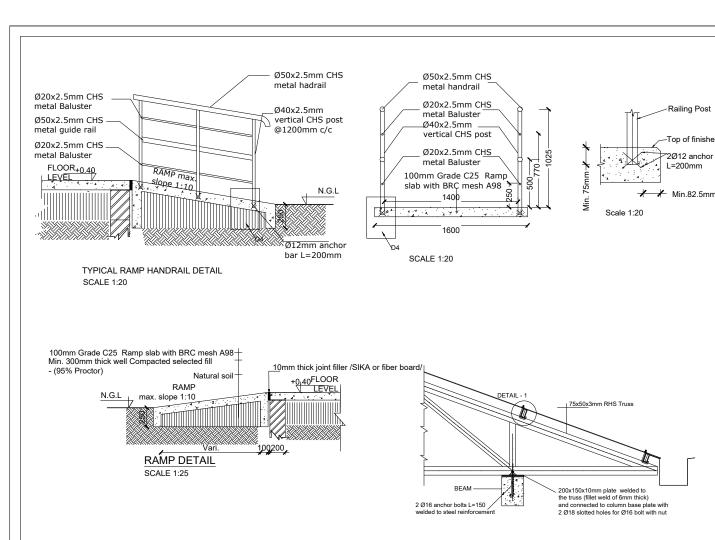

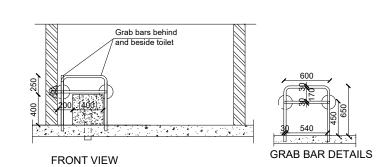



Grab bars behind

200, 400


ACCESSIBLE TOILET PLAN

2Ø12 anchor bars welded to posts.

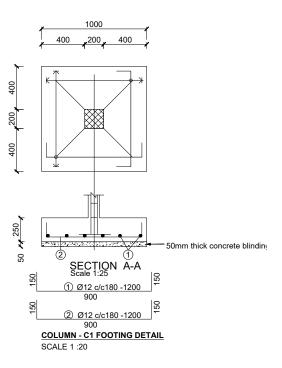

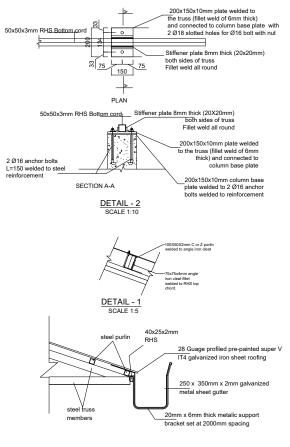

total Length = 1065mm

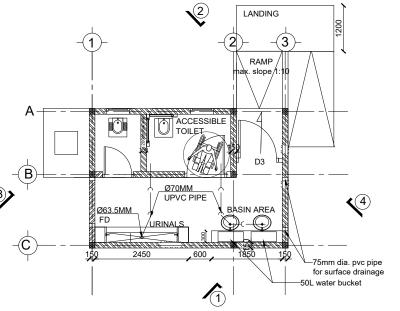

FACILITIES TOILET INTERNAL PLUMPING - (MALE)





- All dimensions are in millimeters unless otherwise stated. All dimensions are to checked and confirmed on site before
- commencement of any work.
 Written dimensions overrides scaled dimensions.

- Depth of pad foundation 800mm.

 Depth of strip foundation 600mm.
- Any discrepancy or changes is to be reported to IOM site Engineer/Project manager before proceeding



Program



Enhancing Community Resilience and Local Governance Project

GOVERNMENT OF SOUTH SUDAN

Implemented By:



Project:

PROPOSED VIP LATRINES (MALE)

A BLOCK OF TWO STANCE (NORMAL SOIL)

Drawing Tittle

STRUCTUF	RAL DETAILS	
Designed By	7: H.A	Drawn by: H.A
Checked:	F.E & G.O	Approved:
Sheet #:	6/6	Scale: AS SPECIFIED
Date:	22 July 2024	Rev: 0

SANITATION FACILITIES - A BLOCK OF TWO STANCE VIP LATRINES (FEMALE) (NORMAL SOIL)



- All dimensions are in millimeters unless otherwise stated.
 All dimensions are to checked and confirmed on site before
- An unifications are to checked and confirmed on a commencement of any work.
 Written dimensions overrides scaled dimensions.
 Depth of pad foundation 800mm.
 Depth of strip foundation 600mm.

- Any discrepancy or changes is to be reported to IOM site Engineer/Project manager before proceeding

Rev:	Date	Description:	Approved
	//		
	//		
	//		
	//		

Program



GOVERNMENT OF SOUTH SUDAN

Implemented By:




PROPOSED VIP LATRINES (FEMALE)

A BLOCK OF TWO STANCE (NORMAL SOIL)

Drawing Tittle


COVER PAGE

Designed By:	H.A	Drawn by: H.A
Checked:	F.E & G.O	Approved:
Sheet #:	1/5	Scale: AS SPECIFIED
Date:	22 July 2024	Rev: 0

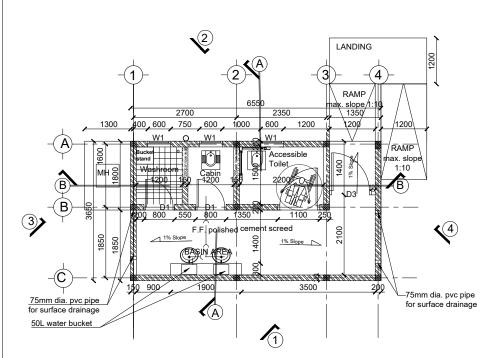


675 1350 675 FACILITIES TOILET ROOF PLAN - (FEMALE)


Sc. 1:50

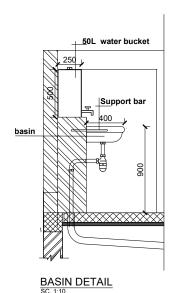

FACILITIES TOILET FLOOR PLAN - (FEMALE)

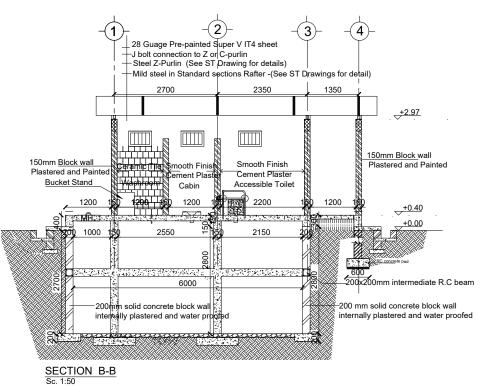

6000 FACILITIES TOILET PIT PLAN - (FEMALE) Sc. 1:50

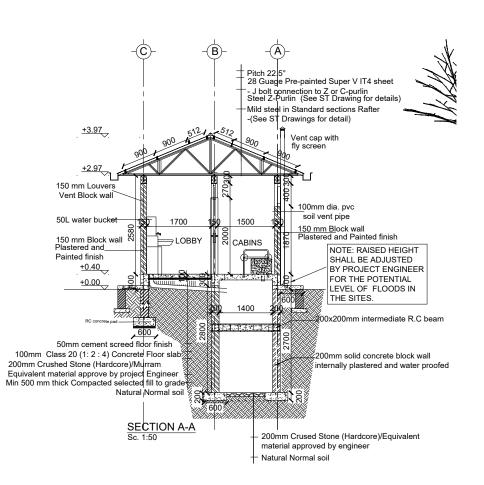



- All dimensions are in millimeters unless otherwise stated.
- All dimensions are to checked and confirmed on site before
- commencement of any work.
 Written dimensions overrides scaled dimensions.
- Depth of pad foundation 800mm.
- Depth of strip foundation 600mm.
- Any discrepancy or changes is to be reported to IOM site Engineer/Project manager before proceeding

ev:	Date	Description:	Approved

Program



GOVERNMENT OF SOUTH SUDAN



Project:


PROPOSED VIP LATRINES (FEMALE)

A BLOCK OF TWO STANCE AND WASHROOM (BLACK COTTON SOIL)

Drawing Tittle


FLOOR PLAN, ROOF PLAND AND SECTIONS

Checked:	F.E & G.O	Approved:
Sheet #:	2/5	Scale: AS SPECIFIED

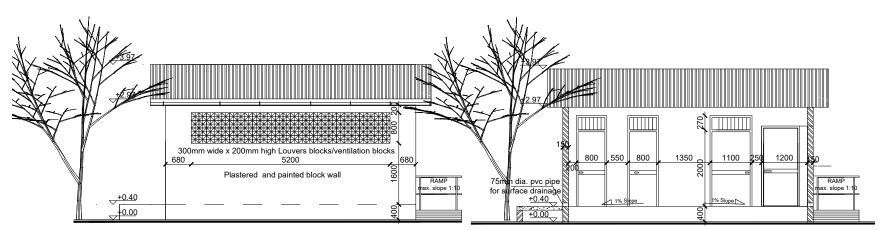


FRONT SIDE ELEVATION 1

FRONT SIDE ELEVATION 1A (without front wall)

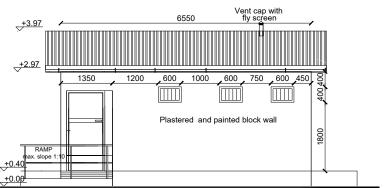



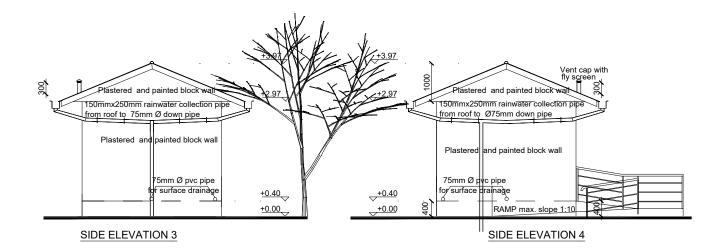



DOOR SCHEDULE

Door Name	D1	D2	D3
Quantity	2	1	1
Frame material	RHS steel frame 40mm x 40mm x 2mm	RHS steel frame 40mm x 40mm x 2mm	RHS steel frame 40mm x 40mm x 2mm
Frame finish	Painted with 2 coats of antirust paint & 2 coats of enamel paint	Painted with 2 coats of antirust paint & 2 coats of enamel paint	Painted with 2 coats of antirust paint & 2 coats of enamel paint
Door leaf construction	90D opening made of 1.5mm flat metal pane	90D opening made of 1.5mm flat metal pane	90D opening made of 1.5mm flat metal pane
Burglar Proofing		RHS 25X25X2 mm vertical steel bars at equal intervals welded to frames on the interior side	RHS 25X25X2 mm vertical steel bars at equal intervals welded to frames on the interior side
Ironmongry	stainless steel pull-push bar handle	stainless steel pull-push bar handle	stainless steel pull-push bar handle
Louver	0.5mm thick steel louvers welded at top to the frame.	0.5mm thick steel louvers welded at top to the frame.	
	900 1100 270	900 1100 2270	1100 100

WINDOW SCHEDULE

Window Name	W1	
Quantity	3	
Frame material	RHS steel frame 40mm x 40mm x 2mm	
Frame finish	Painted with 2 coats of antirust paint & 2 coats of enamel paint	
Burglar proofing		
Louvers	Steel Louver	
	+0.00 +	

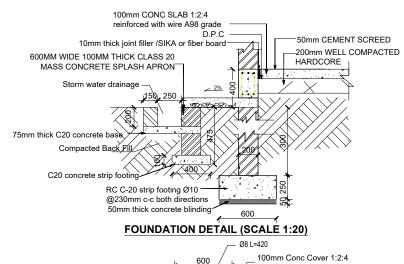

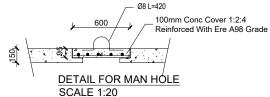



- All dimensions are in millimeters unless otherwise stated.
- 2. All dimensions are to checked and confirmed on site before
- commencement of any work.
 Written dimensions overrides scaled dimensions.
- Depth of pad foundation 800mm.
 Depth of strip foundation 600mm.
- Any discrepancy or changes is to be reported to IOM site Engineer/Project manager before proceeding

Rev:	Date	Description:	Approved



GOVERNMENT OF SOUTH SUDAN




PROPOSED VIP LATRINES (FEMALE)


A BLOCK OF TWO STANCE (BLACK COTTON SOIL)


Drawing Tittle

ELEVATIONS AND DETAILS

Designed By: H.A	Drawn by: H.A
Checked: F.E & G.	O Approved:
Sheet #: 3/5	Scale: AS SPECIFIED
Date:	Rev: 0

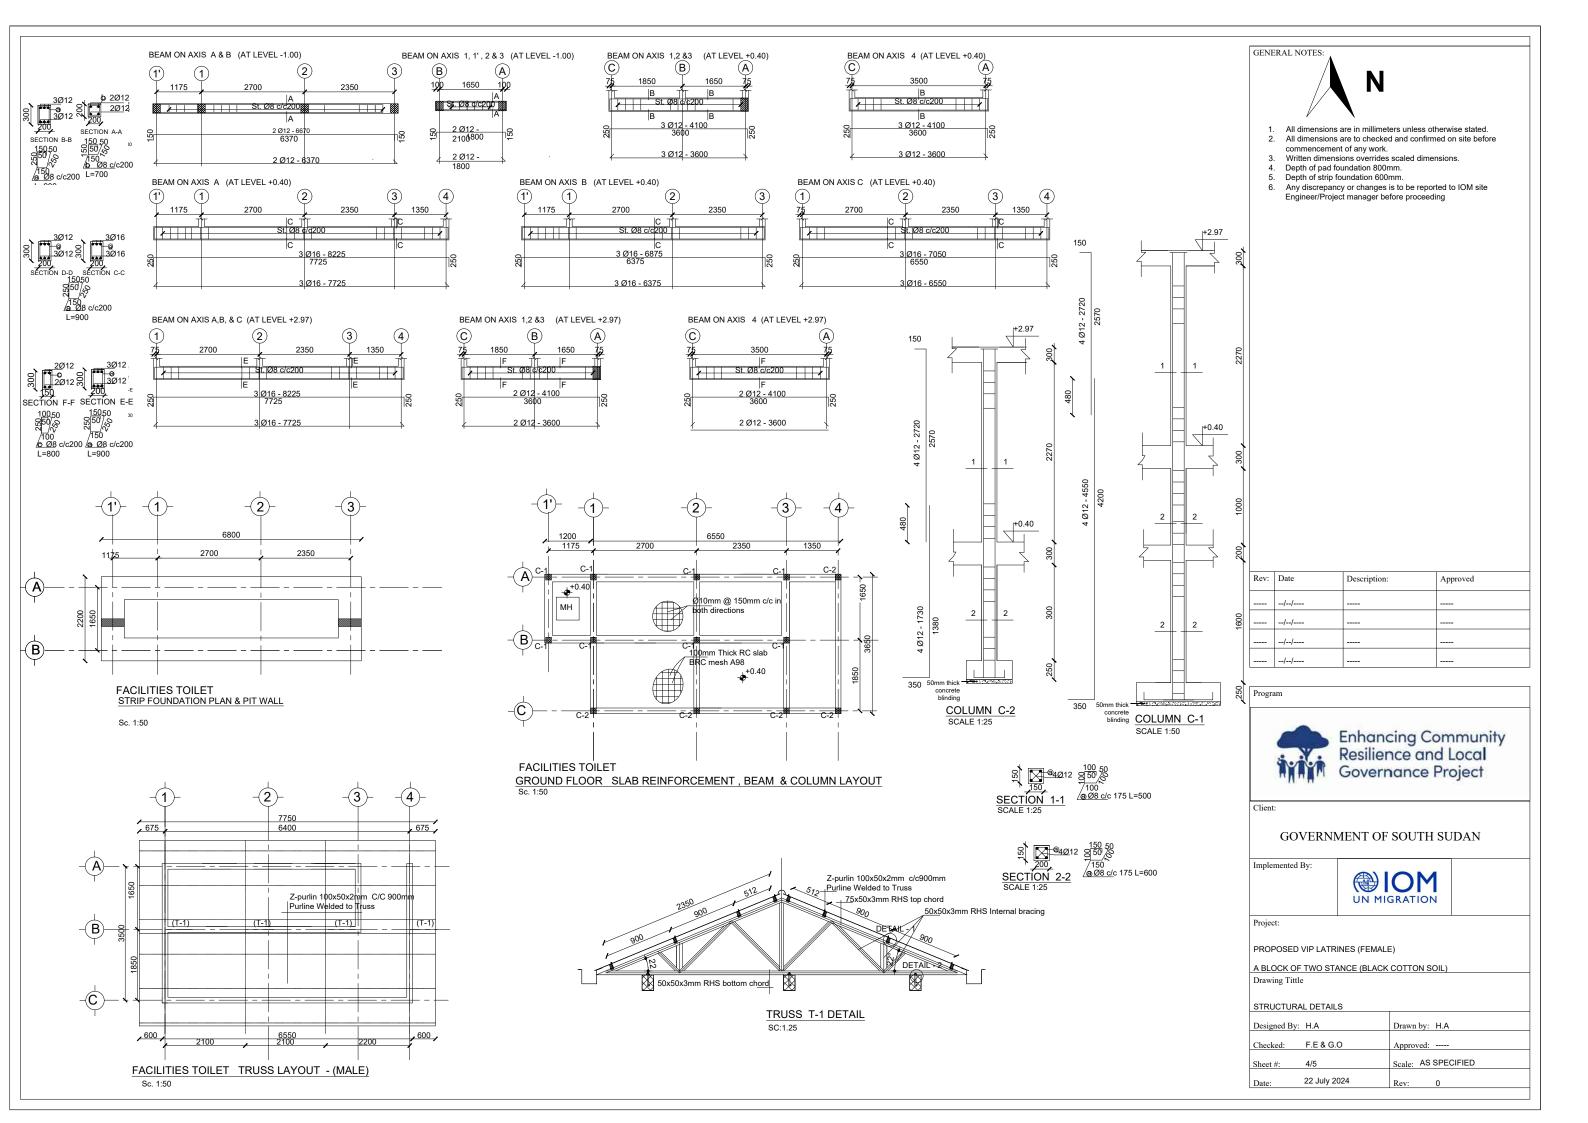

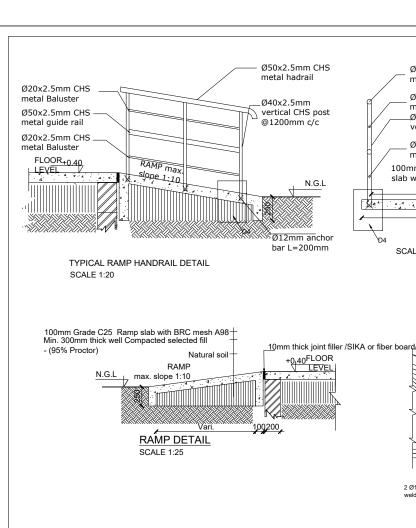

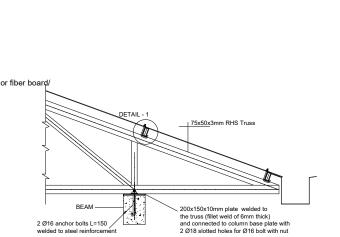

-Top of finished concrete slab

L=200mm

Scale 1:20

bracket set at 2000mm spacing

Detail 01: Overhung Gutter Detail

total Length = 1065mm

2Ø12 anchor bars welded to posts

Ø50x2.5mm CHS

Ø20x2.5mm CHS

vertical CHS post

Ø20x2.5mm CHS

100mm Grade C25 Ramp

slab with BRC mesh A98

1400


SCALE 1:20


metal Baluster

metal handrail


metal Baluster

_Ø40x2.5mm

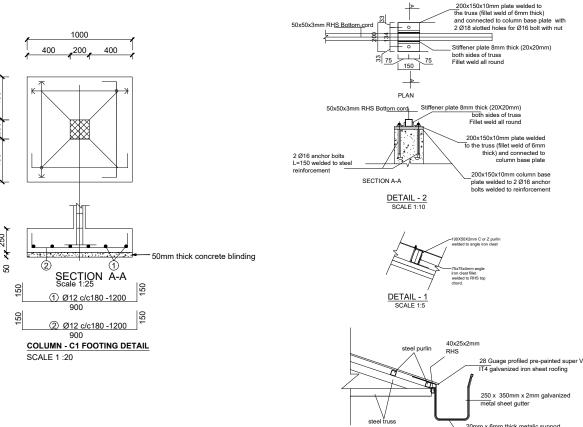

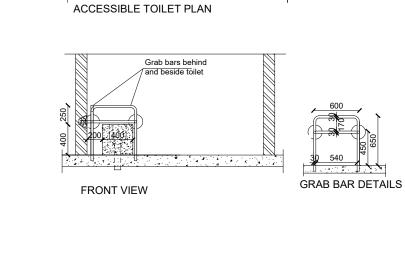

Grab bars behind and beside toilet

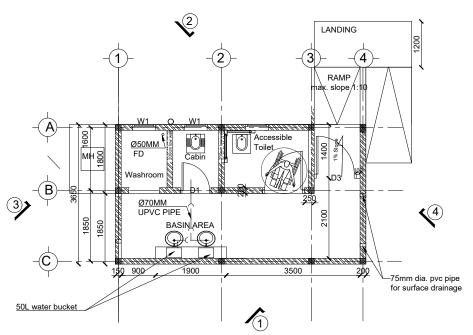

FACILITIES TOILET INTERNAL PLUMPING - (FEMALE)





- All dimensions are in millimeters unless otherwise stated. All dimensions are to checked and confirmed on site before
- commencement of any work.
 Written dimensions overrides scaled dimensions.

- Depth of pad foundation 800mm.

 Depth of strip foundation 600mm.
- Any discrepancy or changes is to be reported to IOM site Engineer/Project manager before proceeding

Rev:	Date	Description:	Approved
	//		
	//		
	//		
	//		

Program



Enhancing Community Resilience and Local Governance Project

GOVERNMENT OF SOUTH SUDAN

Implemented By:



Project:

PROPOSED VIP LATRINES (FEMALE)

A BLOCK OF TWO STANCE (BLACK COTTON SOIL)

Drawing Tittle

STRUCTUF	RAL DETAILS	
Designed By	7: H.A	Drawn by: H.A
Checked:	F.E & G.O	Approved:
Sheet #:	5/5	Scale: AS SPECIFIED
Date:	22 July 2024	Rev: 0