# SANITATION FACILITIES- FOUR STANCE VIP LATRINES (MALE) (NORMAL SOIL)



- All dimensions are in millimeters unless otherwise stated.
   All dimensions are to checked and confirmed on site before commencement of any work.
  3. Written dimensions overrides scaled dimensions.

- Written dimensions overrides scaled dimensions.
   Depth of pad foundation 800mm.
   Depth of strip foundation 600mm.
   Any discrepancy or changes is to be reported to IOM site Engineer/Project manager before proceeding

Rev:	Date	Description:	Approved
	//		
	//		
	//		
	//		

## Program



GOVERNMENT OF SOUTH SUDAN

Implemented By:




PROPOSED VIP LATRINES (MALE)

BLOCK OF FOUR STANCE (NORMAL SOIL

Drawing Tittle


COVER PAGE

Drawn	by: H.A
G.O Appro	ved:
Scale:	AS SPECIFIED
2024 Rev:	0
	S.O Appro

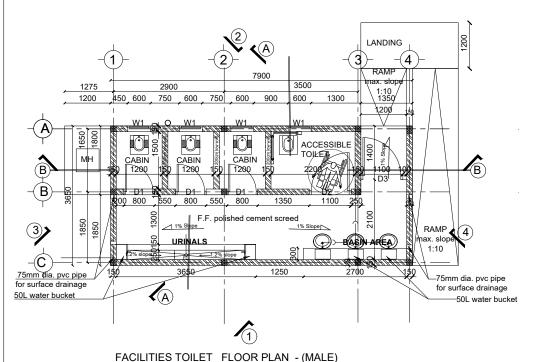

3500 1350

FACILITIES TOILET ROOF PLAN - (MALE)

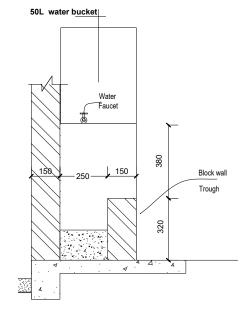



URINAL TROUGH DETAIL


28 Guage Pre-painted Super V IT4 sheet - J bolt connection to Z or C-purlin Steel Z-Purlin (Seel ST Drawing for details) -Mild steel in Standard sections Rafter -(See ST Drawings for detail) 2900 3497 +2.97 150mm Block wall 150mm Block wall
Plastered and Painted Plastered and Painted ACCESSIBLE TOILET CABIN 1200 1200 +0.40 +0.00 975 200mm soul concrete block wall internally plastered and 200 mm solid concrete block wall internally plastered and water proofed

SECTION B-B

Sc. 1:50

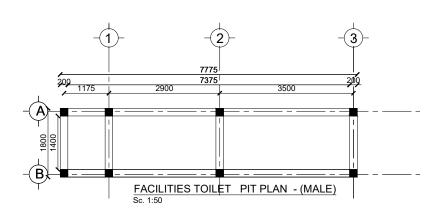

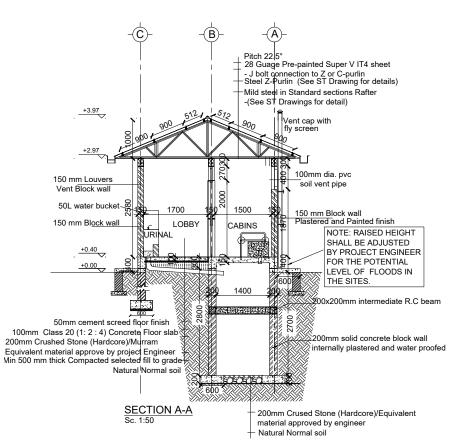

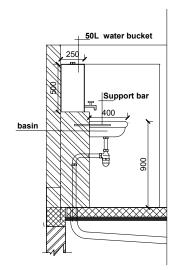

Hand wash Basin Detail SCALE -1:20



- All dimensions are in millimeters unless otherwise stated.
  All dimensions are to checked and confirmed on site before
- commencement of any work.
  Written dimensions overrides scaled dimensions.
- Depth of pad foundation 800mm.

GENERAL NOTES:

- Depth of strip foundation 600mm.
- Any discrepancy or changes is to be reported to IOM site Engineer/Project manager before proceeding

Rev:	Date	Description:	Approved
	//		
	//		
	//		
	//		

Program



Enhancing Community Resilience and Local Governance Project

GOVERNMENT OF SOUTH SUDAN

Implemented By:



Project:


PROPOSED VIP LATRINES (MALE)

A BLOCK OF FOUR STANCE (NORMAL SOIL)

Drawing Tittle


FLOOR PLAN, ROOF PLAN, SECTIONS

Designed B	y: <b>H.A</b>	Drawn by: H.A
Checked:	F.E & G.O	Approved:
Sheet #:	2/6	Scale: AS SPECIFIED
Date:	22 July 2024	Rev: 0

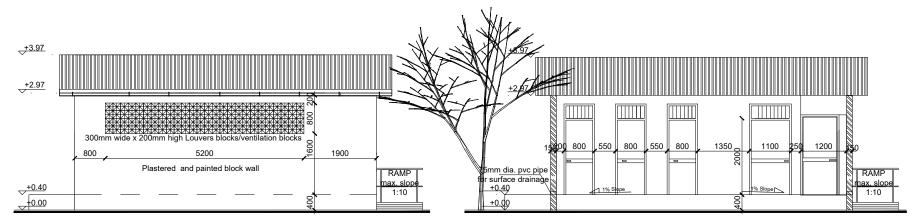

FRONT SIDE ELEVATION 1

FRONT SIDE ELEVATION 1A (without front wall)

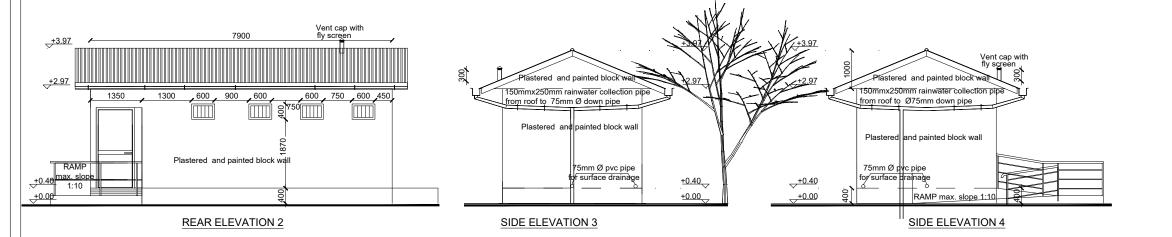


#### DOOR SCHEDULE

Door Name	D1	D2	D3
Quantity	3	1	1
Frame material	RHS steel frame 40mm x 40mm x 2mm	RHS steel frame 40mm x 40mm x 2mm	RHS steel frame 40mm x 40mm x 2mm
Frame finish	Painted with 2 coats of antirust paint & 2 coats of enamel paint	Painted with 2 coats of antirust paint & 2 coats of enamel paint	Painted with 2 coats of antirust paint & 2 coats of enamel paint
Door leaf construction	90D opening made of 1.5mm flat metal pane	90D opening made of 1.5mm flat metal pane	90D opening made of 1.5mm flat metal pane
Burglar Proofing	RHS 25X25X2 mm vertical steel bars at equal intervals welded to frames on the interior side	RHS 25X25X2 mm vertical steel bars at equal intervals welded to frames on the interior side	RHS 25X25X2 mm vertical steel bars at equal intervals welded to frames on the interior side
Ironmongry	stainless steel pull-push bar handle	stainless steel pull-push bar handle	stainless steel pull-push bar handle
Louver	0.5mm thick steel louvers welded at top to the frame.	0.5mm thick steel louvers welded at top to the frame.	
	900 1100 270	900 1100 270	1100 100

#### WINDOW SCHEDULE

Window Name	W1
Quantity	4
Frame material	RHS steel frame 40mm x 40mm x 2mm
Frame finish	Painted with 2 coats of antirust paint & 2 coats of enamel paint
Burglar proofing	
Louvers	Steel Louver
	+2.27 J +1.87 J
	1870
	+0.00

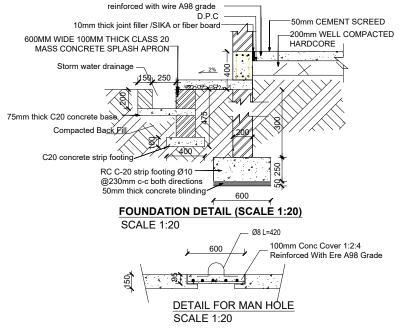

100mm CONC SLAB 1:2:4





- All dimensions are in millimeters unless otherwise stated.
   All dimensions are to checked and confirmed on site before
- commencement of any work.
  Written dimensions overrides scaled dimensions.

- Virtuen dimensions overrices scaled dimensions.

  Depth of pad foundation 800mm.

  Depth of strip foundation 600mm.

  Any discrepancy or changes is to be reported to IOM site Engineer/Project manager before proceeding

Rev:	Date	Description:	Approved
	//		
	//		
	//		
	//		





Client:

GOVERNMENT OF SOUTH SUDAN

Implemented By:



Project:

PROPOSED VIP LATRINES (MALE)

A BLOCK OF FOUR STANCE (NORMAL SOIL) Drawing Tittle

ELEVATIONS AND DETAILS

Designed By:	H.A	Drawn by: H.A
Checked:	F.E & G.O	Approved:
Sheet #:	3/6	Scale: AS SPECIFIED
Date:	22 July 2024	Rev: 0

### **STRUCTURAL NOTES:**

- Building shall be founded on load bearing stone masonry wall having a depth of 600mm and pad foundation footing of 800mm from the natural ground level with bottom of excavation compacted prior to laying the foundation wall.
- II) Stone masonry foundation shall be placed on the natural normal soil and achieve a minimum bearing capacity of 150 KN/m2
- III) Foundation trench excavation to be approved by the Engineer prior to the construction of the stone masonry foundation.
- **Material Specification**
- A) Grade of Structural Concrete

C-25 (Cube characteristics strength of 25 MPa mix ratio 1:1.5:3) for columns and beams;

C-20 (Cube characteristics strength of 20 MPa mix ratio 1:2:4) for floor slab)

Concrete reinforcement bar

Grade 460 (Characteristics yield strength of fyk = 460 MPa)

Steel hollow section for roofing system, verandah column and plates

Grade C: Tensile Strength = 375 Mpa

Yield Strength = 275 Mpa

D) Grade of Bolts

Grade 4.6: Yield Strength = 240 Mpa

Tensile Strength = 400 Mpa

- **Durability Requirements**
- Concrete Cover to Reinforcement
  - Floor slabs: 25mm.
  - Beams: 25mm
  - Columns: 25m
  - All foundation (below the ground level): 50mm
- Protection of steel work
  - Surface preparation by blast cleaning, pickling process or where approved by wire brushing
  - Application of one coat of an approved pre-fabrication fabrication primer e.g. Zinc chromate
  - Two coats of an approved paint system to be proposed by Architect, one applied at shop and the other on site after erection.

#### GENERAL NOTES:



- All dimensions are in millimeters unless otherwise stated All dimensions are to checked and confirmed on site before
- commencement of any work.
  Written dimensions overrides scaled dimensions
- Depth of pad foundation 800mm
- Depth of strip foundation 600mm
- Any discrepancy or changes is to be reported to IOM site

Rev:	Date	Description:	Approved
	//		
	//		
	//		
	//		

#### Program



GOVERNMENT OF SOUTH SUDAN

Implemented By:





PROPOSED VIP LATRINES (MALE)

A BLOCK OF FOUR STANCE (NORMAL SO

Drawing Tittle

STRUCTURAL NOTES	
Designed By: H.A	Drawn by: H.A
Checked: F.E & G.O	Approved:
Sheet #: 4/6	Scale: AS SPECIFIED
Date: 22 July 2024	Rev: 0

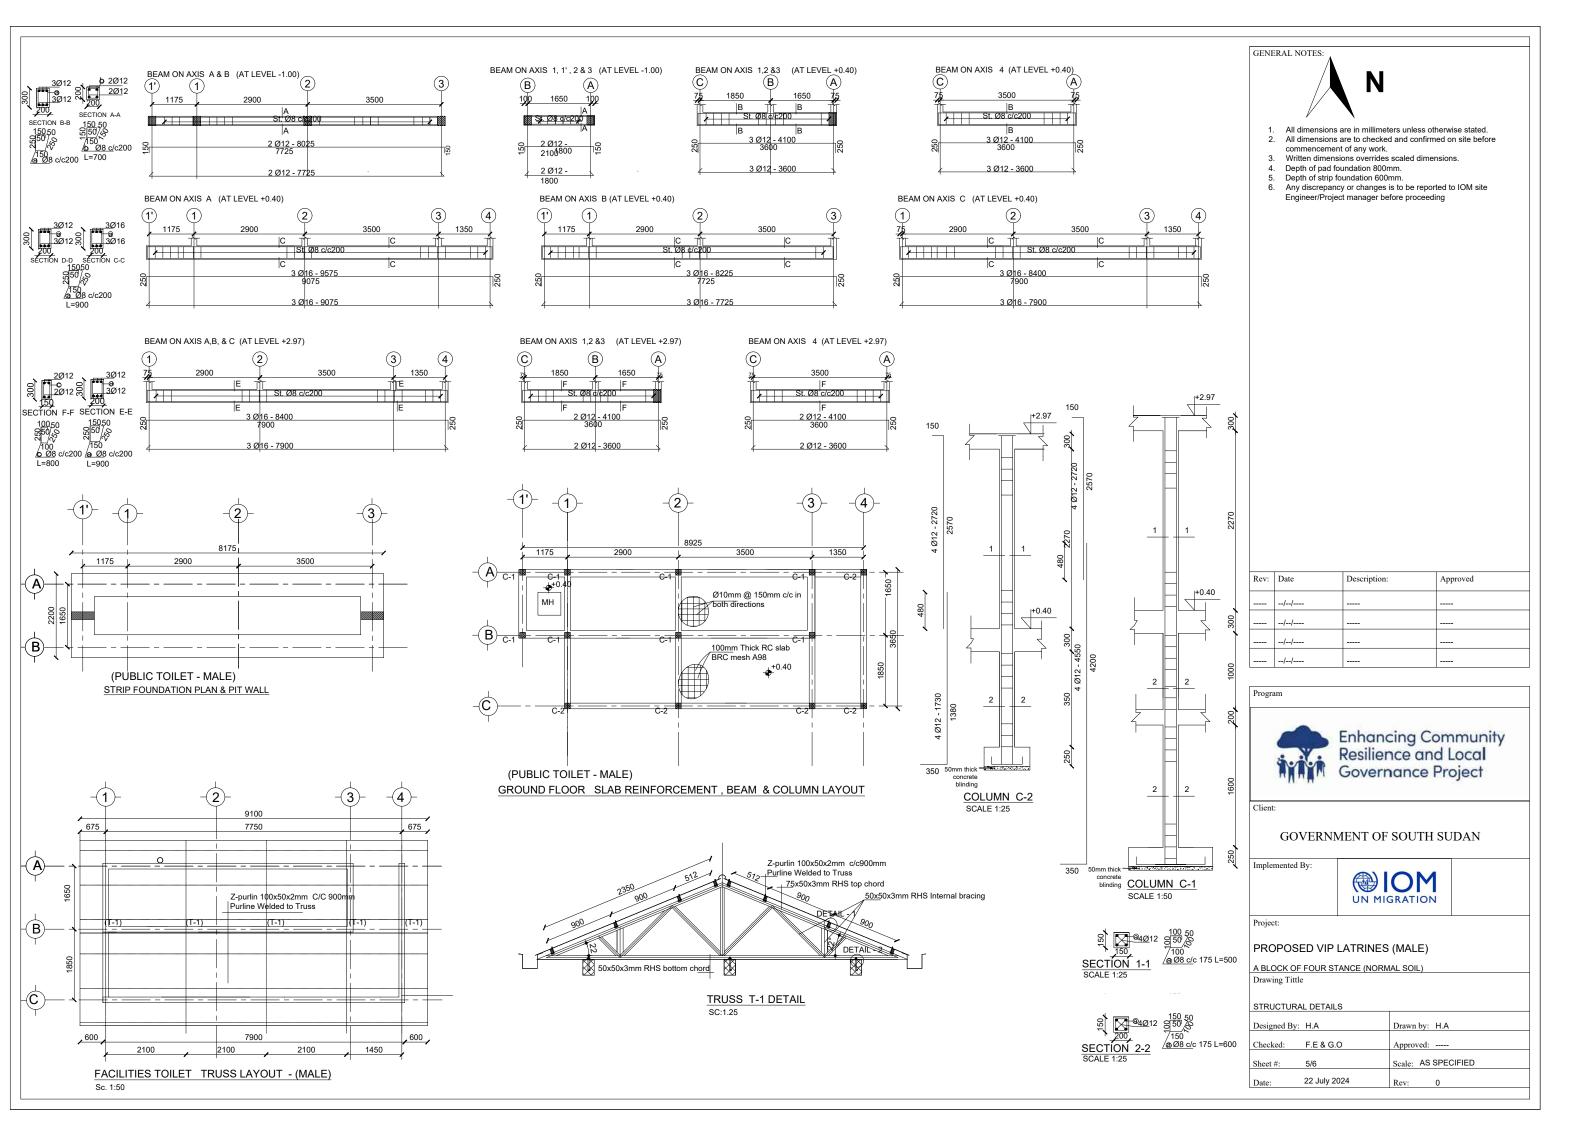

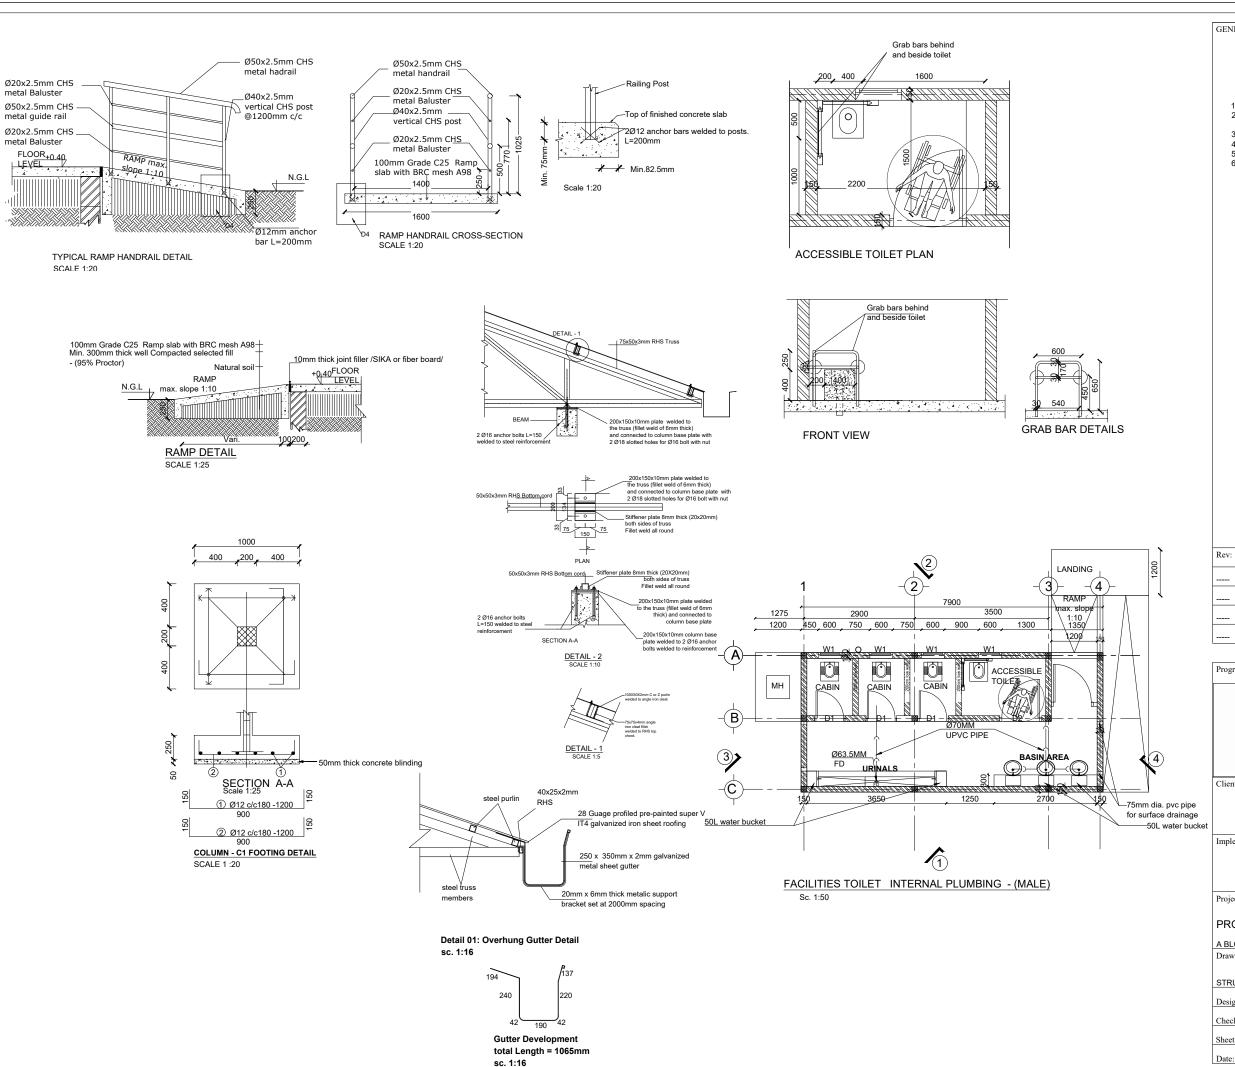





- All dimensions are in millimeters unless otherwise stated.
  All dimensions are to checked and confirmed on site before
- commencement of any work.
  Written dimensions overrides scaled dimensions.
- Depth of pad foundation 800mm.
- Depth of strip foundation 600mm.
- Any discrepancy or changes is to be reported to IOM site Engineer/Project manager before proceeding

Rev:	Date	Description:	Approved
	//		
	//		
	//		
	//		





Enhancing Community Resilience and Local Governance Project

GOVERNMENT OF SOUTH SUDAN

Implemented By:



Project:

PROPOSED VIP LATRINES (MALE)

A BLOCK OF FOUR STANCE (NORMAL SOIL)

Drawing Tittle

STRUCTURAL DETAILS

Designed B	ν. Н Δ	Drawn by: H.A
Designed D	y. 11.A	Diawii by. 11.A
Checked:	F.E & G.O	Approved:
Sheet #:	6/6	Scale: AS SPECIFIED
Date:	22 July 2024	Rev: 0

# SANATATION FACILITIES- FOUR STANCE VIP LATRINES (FEMALE) (NORMAL SOIL)





- All dimensions are in millimeters unless otherwise stated.
   All dimensions are to checked and confirmed on site before commencement of any work.
  3. Written dimensions overrides scaled dimensions.

- Written dimensions overrides scaled dimensions.
   Depth of pad foundation 800mm.
   Depth of strip foundation 600mm.
   Any discrepancy or changes is to be reported to IOM site Engineer/Project manager before proceeding

Rev:	Date	Description:	Approved
	//		
	//		
	//		
	//		

#### Program



GOVERNMENT OF SOUTH SUDAN

Implemented By:




PROPOSED VIP LATRINES (FEMALE)

BLOCK OF FOUR STANCE AND WASHROOM (NORMAL SOIL)


Drawing Tittle


COVER PAGE


Designed By:	H.A	Drawn by: H.A
Checked:	F.E & G.O	Approved:
Sheet #:	1/5	Scale: AS SPECIFIED
Date:	22 July 2024	Rev: 0
Date.	22 04., 202 .	Rev. 0

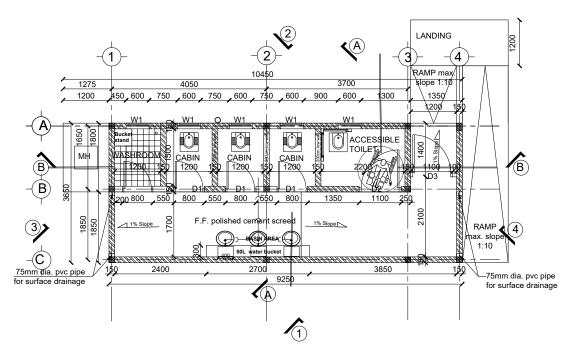


FACILITIES TOILET FLOOR PLAN - (FEMALE)

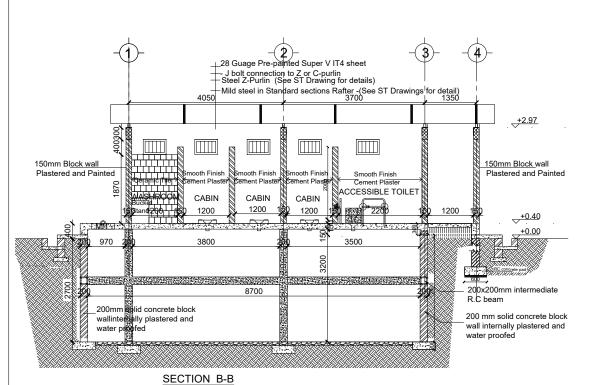

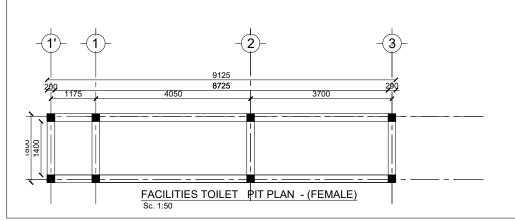

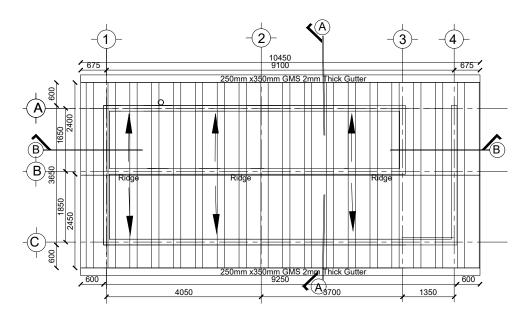

FACILITIES TOILET ROOF PLAN - (FEMALE) Sc. 1:50

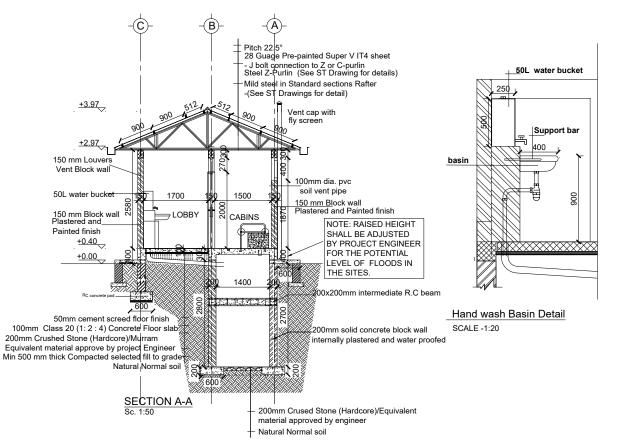





- All dimensions are in millimeters unless otherwise stated.
  All dimensions are to checked and confirmed on site before
- commencement of any work.
  Written dimensions overrides scaled dimensions.
- Depth of pad foundation 800mm.
- Depth of strip foundation 600mm.
- Any discrepancy or changes is to be reported to IOM site Engineer/Project manager before proceeding



Program



Enhancing Community Resilience and Local Governance Project

GOVERNMENT OF SOUTH SUDAN

Implemented By:



Project:


PROPOSED VIP LATRINES (FEMALE)

A BLOCK OF FOUR STANCE AND WASHROOM (NORMAL SOIL)

Drawing Tittle


FLOOR PLAN, ROOF PLAN, SECTIONS


Designed B	y: H.A	Drawn by: H.A
Checked:	F.E & G.O	Approved:
Sheet #:	2/5	Scale: AS SPECIFIED
Date:	22 July 2024	Rev: 0

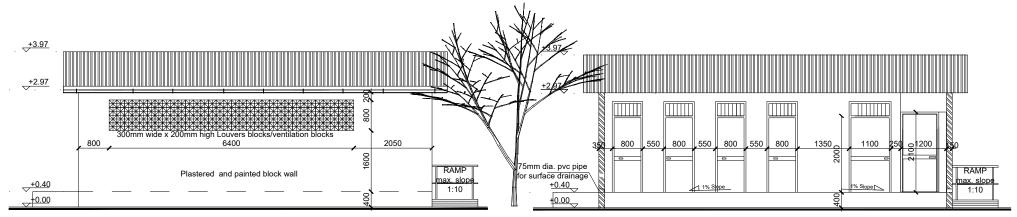

#### FRONT SIDE ELEVATION 1

FRONT SIDE ELEVATION 1A (without front wall)

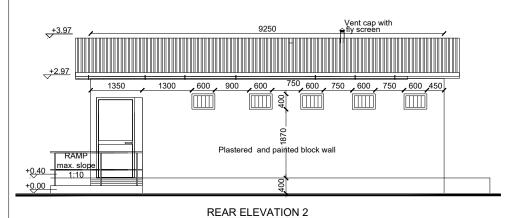

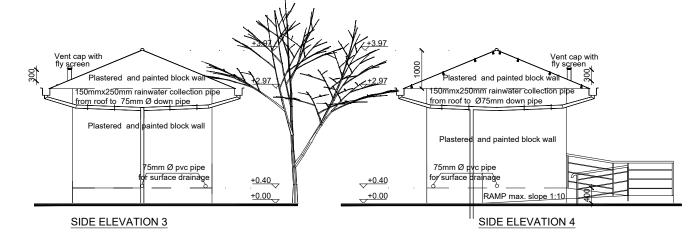


#### DOOR SCHEDULE

	]			
Door Name	D1	D2	D3	
Quantity	4	1	1	
Frame material	RHS steel frame 40mm x 40mm x 2mm	RHS steel frame 40mm x 40mm x 2mm	RHS steel frame 40mm x 40mm x 2mm	
Frame finish	Painted with 2 coats of antirust paint & 2 coats of enamel paint	Painted with 2 coats of antirust paint & 2 coats of enamel paint	Painted with 2 coats of antirust paint & 2 coats of enamel paint	
Door leaf construction	90D opening made of 1.5mm flat metal pane	90D opening made of 1.5mm flat metal pane	90D opening made of 1.5mm flat metal pane	
Burglar Proofing		RHS 25X25X2 mm vertical steel bars at equal intervals welded to frames on the interior side	RHS 25X25X2 mm vertical steel bars at equal intervals welded to frames on the interior side	
Ironmongry	stainless steel pull-push bar handle	stainless steel pull-push bar handle	stainless steel pull-push bar handle	
Louver 0.5mm thick steel louvers welded at top to the frame.		0.5mm thick steel louvers welded at top to the frame.		
	900 1100 270	1100 2200	1100 100	

#### WINDOW SCHEDULE

Window Name	W1	
Quantity	5	
Frame material	RHS steel frame 40mm x 40mm x 2mm	
Frame finish	Painted with 2 coats of antirust paint & 2 coats of enamel paint	
Burglar proofing		
Louvers	Steel Louver	
	+1.87 000 00 00 00 00 00 00 00 00 00 00 00 0	
	+0.00	

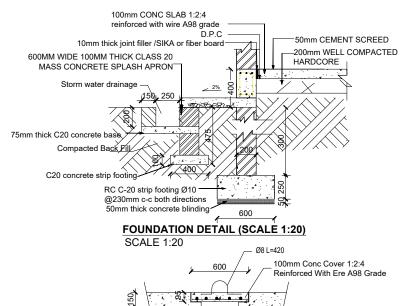

DETAIL FOR MAN HOLE

SCALE 1:20



- All dimensions are in millimeters unless otherwise stated.
   All dimensions are to checked and confirmed on site before
- commencement of any work.
  Written dimensions overrides scaled dimensions.

- Depth of pad foundation 800mm.
  Depth of strip foundation 600mm.
  Any discrepancy or changes is to be reported to IOM site Engineer/Project manager before proceeding

Rev:	Date	Description:	Approved
	//		
	//		
	//		
	//		

## Program



Client:

GOVERNMENT OF SOUTH SUDAN

Implemented By:



PROPOSED VIP LATRINES (FEMALE)

A BLOCK OF FOUR STANCE AND WASHROOM (NORMAL SOIL) Drawing Tittle

ELEVATIONS AND DETAILS

ELEVATIONS AND DETAILS		
Designed By:		Drawn by: H.A
Checked:		Approved:
Sheet #:	3/5	Scale: AS SPECIFIED
Date:	22 July 2024	Rev: 0

